

Project Number: 757-17-207
EXPAND SPECIMEN COLLECTION AREA


PREPARED FOR:
DEPARTMENT OF VETERANS AFFAIRS
CHALMERS P. WYLIE
VA AMBULATORY CARE CENTER
420 NORTH JAMES ROAD
COLUMBUS OH 43219

PREPARED BY:
M+A ARCHITECTS
775 YARD STREET, SUITE 325
COLUMBUS OH 43212




SCHEDULE OF DRAWINGS	
G10-01	COVER
G10-02	ARCHITECTURAL LEGEND AND ABBREVIATIONS
G10-03	ACCESSIBILITY STANDARDS
G10-04	OVERALL AND PARTIAL THIRD FLOOR LIFE SAFETY PLANS
A1.3.1	DEMOLITION PLANS
A2.3.1	PARTIAL THIRD FLOOR - NEW WORK PLANS
A3.3.1	PHASING PLANS
A8.3.1	INTERIOR ELEVATIONS AND DETAILS
A9.3.1	PARTIAL THIRD FLOOR - FINISH AND EQUIPMENT PLANS
P000 -	PLUMBING & FIRE PROTECTION LEGEND
PL101 -	PARTIAL THIRD FLOOR - PLUMBING & FIRE PROTECTION DEMO & NEW WORK PLAN
M000 -	HVAC LEGEND & ABBREVIATIONS
MH101 -	PARTIAL THIRD FLOOR HVAC DEMO & NEW WORK PLAN
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EP101 -	PARTIAL THIRD FLOOR - POWER NEW WORK PLAN
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TD101 -	PARTIAL THIRD FLOOR - TECHNOLOGY DEMOLITION PLAN
TS101 -	PARTIAL THIRD FLOOR - TECHNOLOGY NEW WORK PLAN

<div><div><div>CONTRACT DOCUMENTS - BID SET7/10/15</div><div>CONTRACT DOCUMENTS - 100%6/10/15</div><div>CONTRACT DOCUMENTS - 90% REVIEW SET5/15/15</div><div>DESIGN DEVELOPMENT - 60% REVIEW SET4/10/15</div><div>Revisions:Date</div></div><div><div><div>Dynamix</div><div>Engineering Ltd.</div><div>Facility Engineering Consultants</div><div>855 Grandview Avenue, 3rd Floor Columbus, OH 43215</div><div>Phone: (614) 443-1178 Fax: (614) 443-1594</div><div>Email: dynamix@dynamix-fid.com</div><div>DEL # 130566</div></div></div></div>		<div><div>STATE OF OHIO</div><div>MARK R. HOLLERN</div><div>8833</div><div>REGISTERED ARCHITECT</div><div>MARK R. HOLLERN #8833</div><div>EXPIRATION DATE 12-31-2015</div></div>	<div>ARCHITECT/ENGINEERS:</div> <div><div><div>ma</div><div>775 Yard Street, Suite 325</div><div>Columbus, Ohio 43212</div><div>p 614.764.0407</div><div>f 614.764.0237</div><div>www.ma-architects.com</div></div></div>	<div>CONSTRUCTION DOCUMENTS - BID SET</div> <table><tr><td colspan="2">Drawing Title</td><td colspan="2">Project Title</td><td colspan="2">Project Number</td></tr><tr><td colspan="2">COVER</td><td colspan="2">Expand Specimen Collection Area</td><td colspan="2">757-17-207</td></tr><tr><td colspan="2">Approved:</td><td colspan="2">Location</td><td colspan="2">Building Number</td></tr><tr><td colspan="2"></td><td colspan="2">CHALMERS P. WYLIE VA AMBULATORY CARE CENTER</td><td colspan="2">1A</td></tr><tr><td colspan="2">Date</td><td>Checked By:</td><td>Drawn By:</td><td colspan="2">Drawing Number</td></tr><tr><td colspan="2">10 JULY 2015</td><td>ds</td><td>mnh</td><td colspan="2">G10-01</td></tr></table> <div><div>Office of Construction and Facilities Management</div><div><div>Columbus VA</div><div>Chalmers P. Wylie Ambulatory Care Center</div></div><div><div>Department of Veterans Affairs</div></div></div>				Drawing Title		Project Title		Project Number		COVER		Expand Specimen Collection Area		757-17-207		Approved:		Location		Building Number				CHALMERS P. WYLIE VA AMBULATORY CARE CENTER		1A		Date		Checked By:	Drawn By:	Drawing Number		10 JULY 2015		ds	mnh	G10-01	
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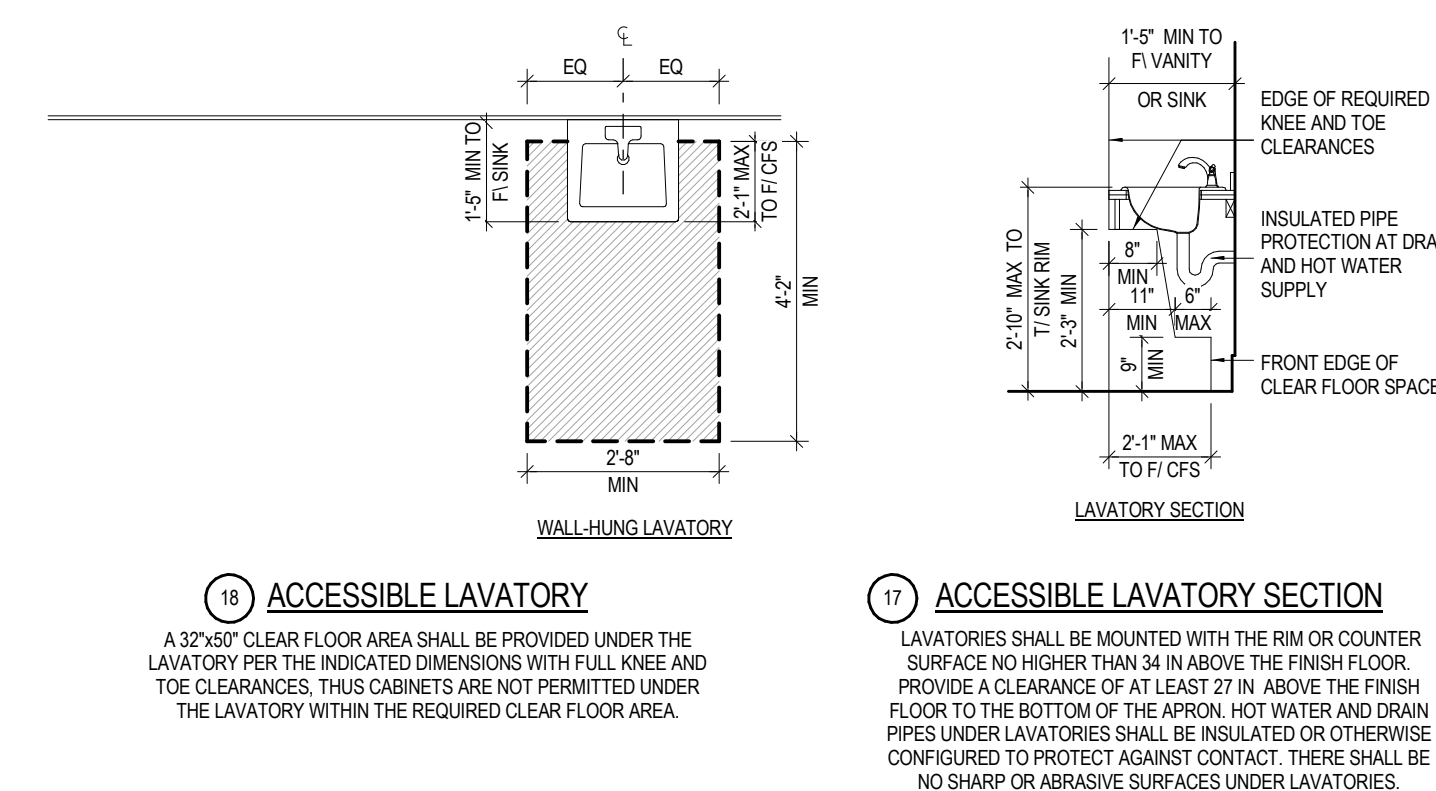
building blocks

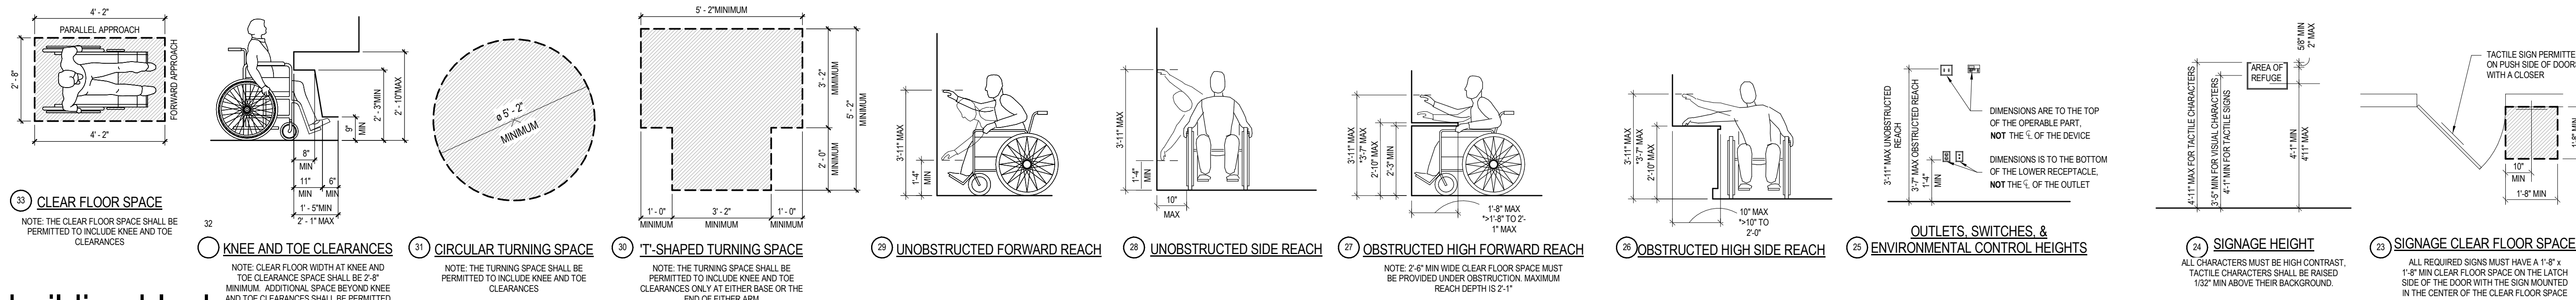3/16"=1'-0"




accessible route

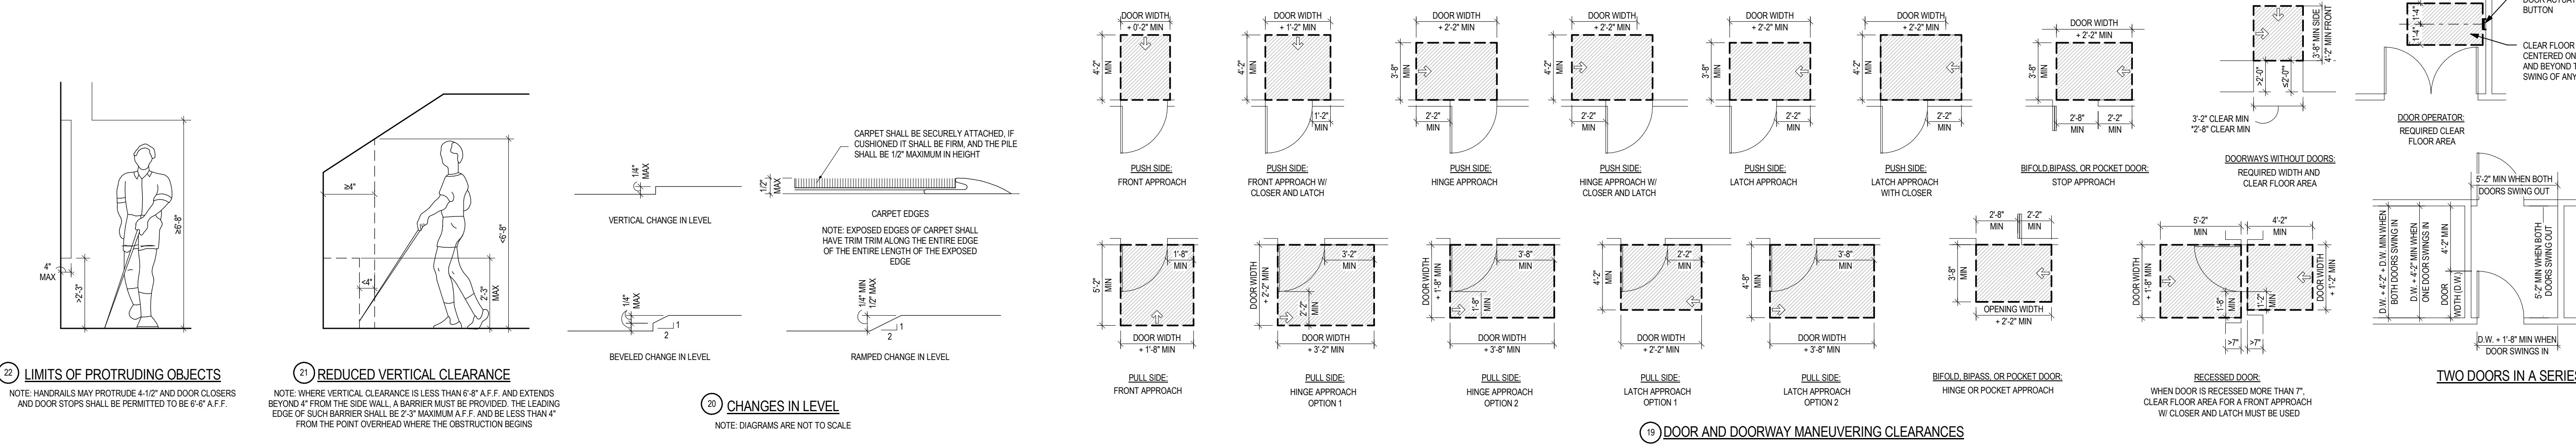3/16"=1'-0"



accessible lavatories and water closets

3/16"=1'-0"

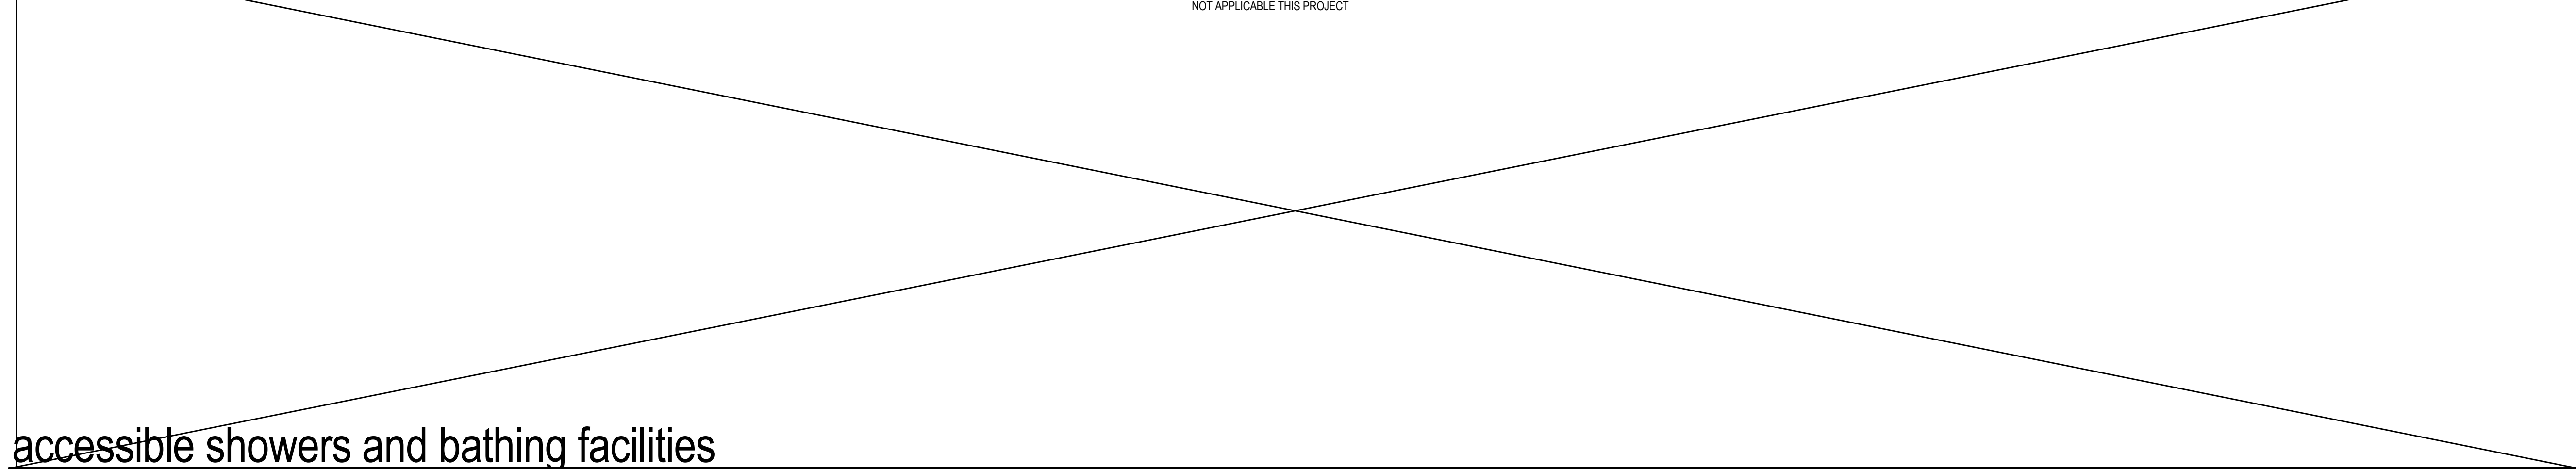

accessible showers and bathing facilities

3/16"=1'-0"


accessible kitchens, break rooms, & appliances

NOTE: THESE DIAGRAMS ARE BASED ON THE AMERICANS WITH DISABILITIES ACT ACCESSIBLE GUIDELINES, 2010 EDITION AS WELL AS ANSI A117.1-2009. NOT ALL CONDITIONS SHOWN MAY EXIST IN THE PROJECT. CONTRACTOR SHALL REVIEW ALL DIAGRAMS PRIOR TO LAYOUT AND VERIFY ALL CLEAR AREAS, MOUNTING HEIGHTS, AND OTHER CLEARANCES AS SHOWN ARE PROVIDED. MATERIALS, PRODUCTS AND SIZES OF FIXTURES AND EQUIPMENT SHOWN MAY NOT REFLECT THE ACTUAL PRODUCTS OR MATERIALS SPECIFIED IN THE ARCHITECTURAL DRAWINGS. REFER TO THE ACTUAL PRODUCT SPECIFIED OR PROVIDED FOR VERIFICATION.

CONTRACT DOCUMENTS - BID SET	7/10/15
CONTRACT DOCUMENTS - 100%	6/10/15
CONTRACT DOCUMENTS - 90% REVIEW SET	5/15/15
DESIGN DEVELOPMENT - 60% REVIEW SET	4/10/15
Revisions:	Date



CONSULTANTS:

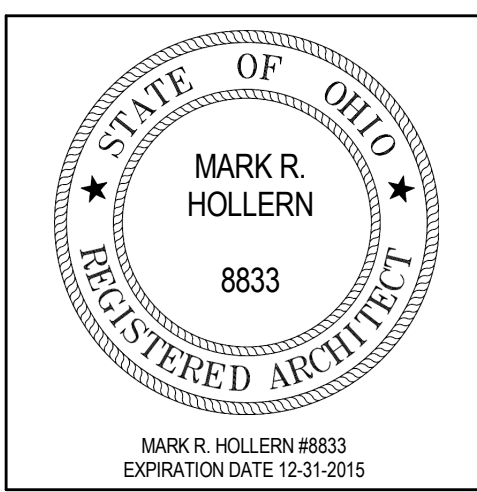Dynamix Engineering Ltd.
Facility Engineering Consultants
855 Grandview Avenue, 3rd Floor Columbus, OH 43215
Phone: (614) 443-1178 Fax: (614) 443-1594
Email: dynamix@dynamix-tld.com
DEL # 13066



ARCHITECT/ENGINEERS:

ma
775 Yard Street, Suite 325
Columbus, Ohio 43212
p 614.764.0407
f 614.764.0237
www.ma-architects.com


CONSTRUCTION DOCUMENTS – BID SET								
Drawing Title		Project Title			Project Number			
ACCESSIBILITY STANDARDS		Expand Specimen Collection Area			757-17-207			
					Building Number			
		1A			<div>Office of Construction and Facilities Management</div> <div> Columbus VA Chalmers P. Wylie Ambulatory Care Center</div> <div> Department of Veterans Affairs</div>			
Approved:		Location					Drawing Number	
		CHALMERS P. WYLIE VA AMBULATORY CARE CENTER					G10-03	
		Date	Checked By:	Drawn By:				
		10 JULY 2015	ds	M+A				

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

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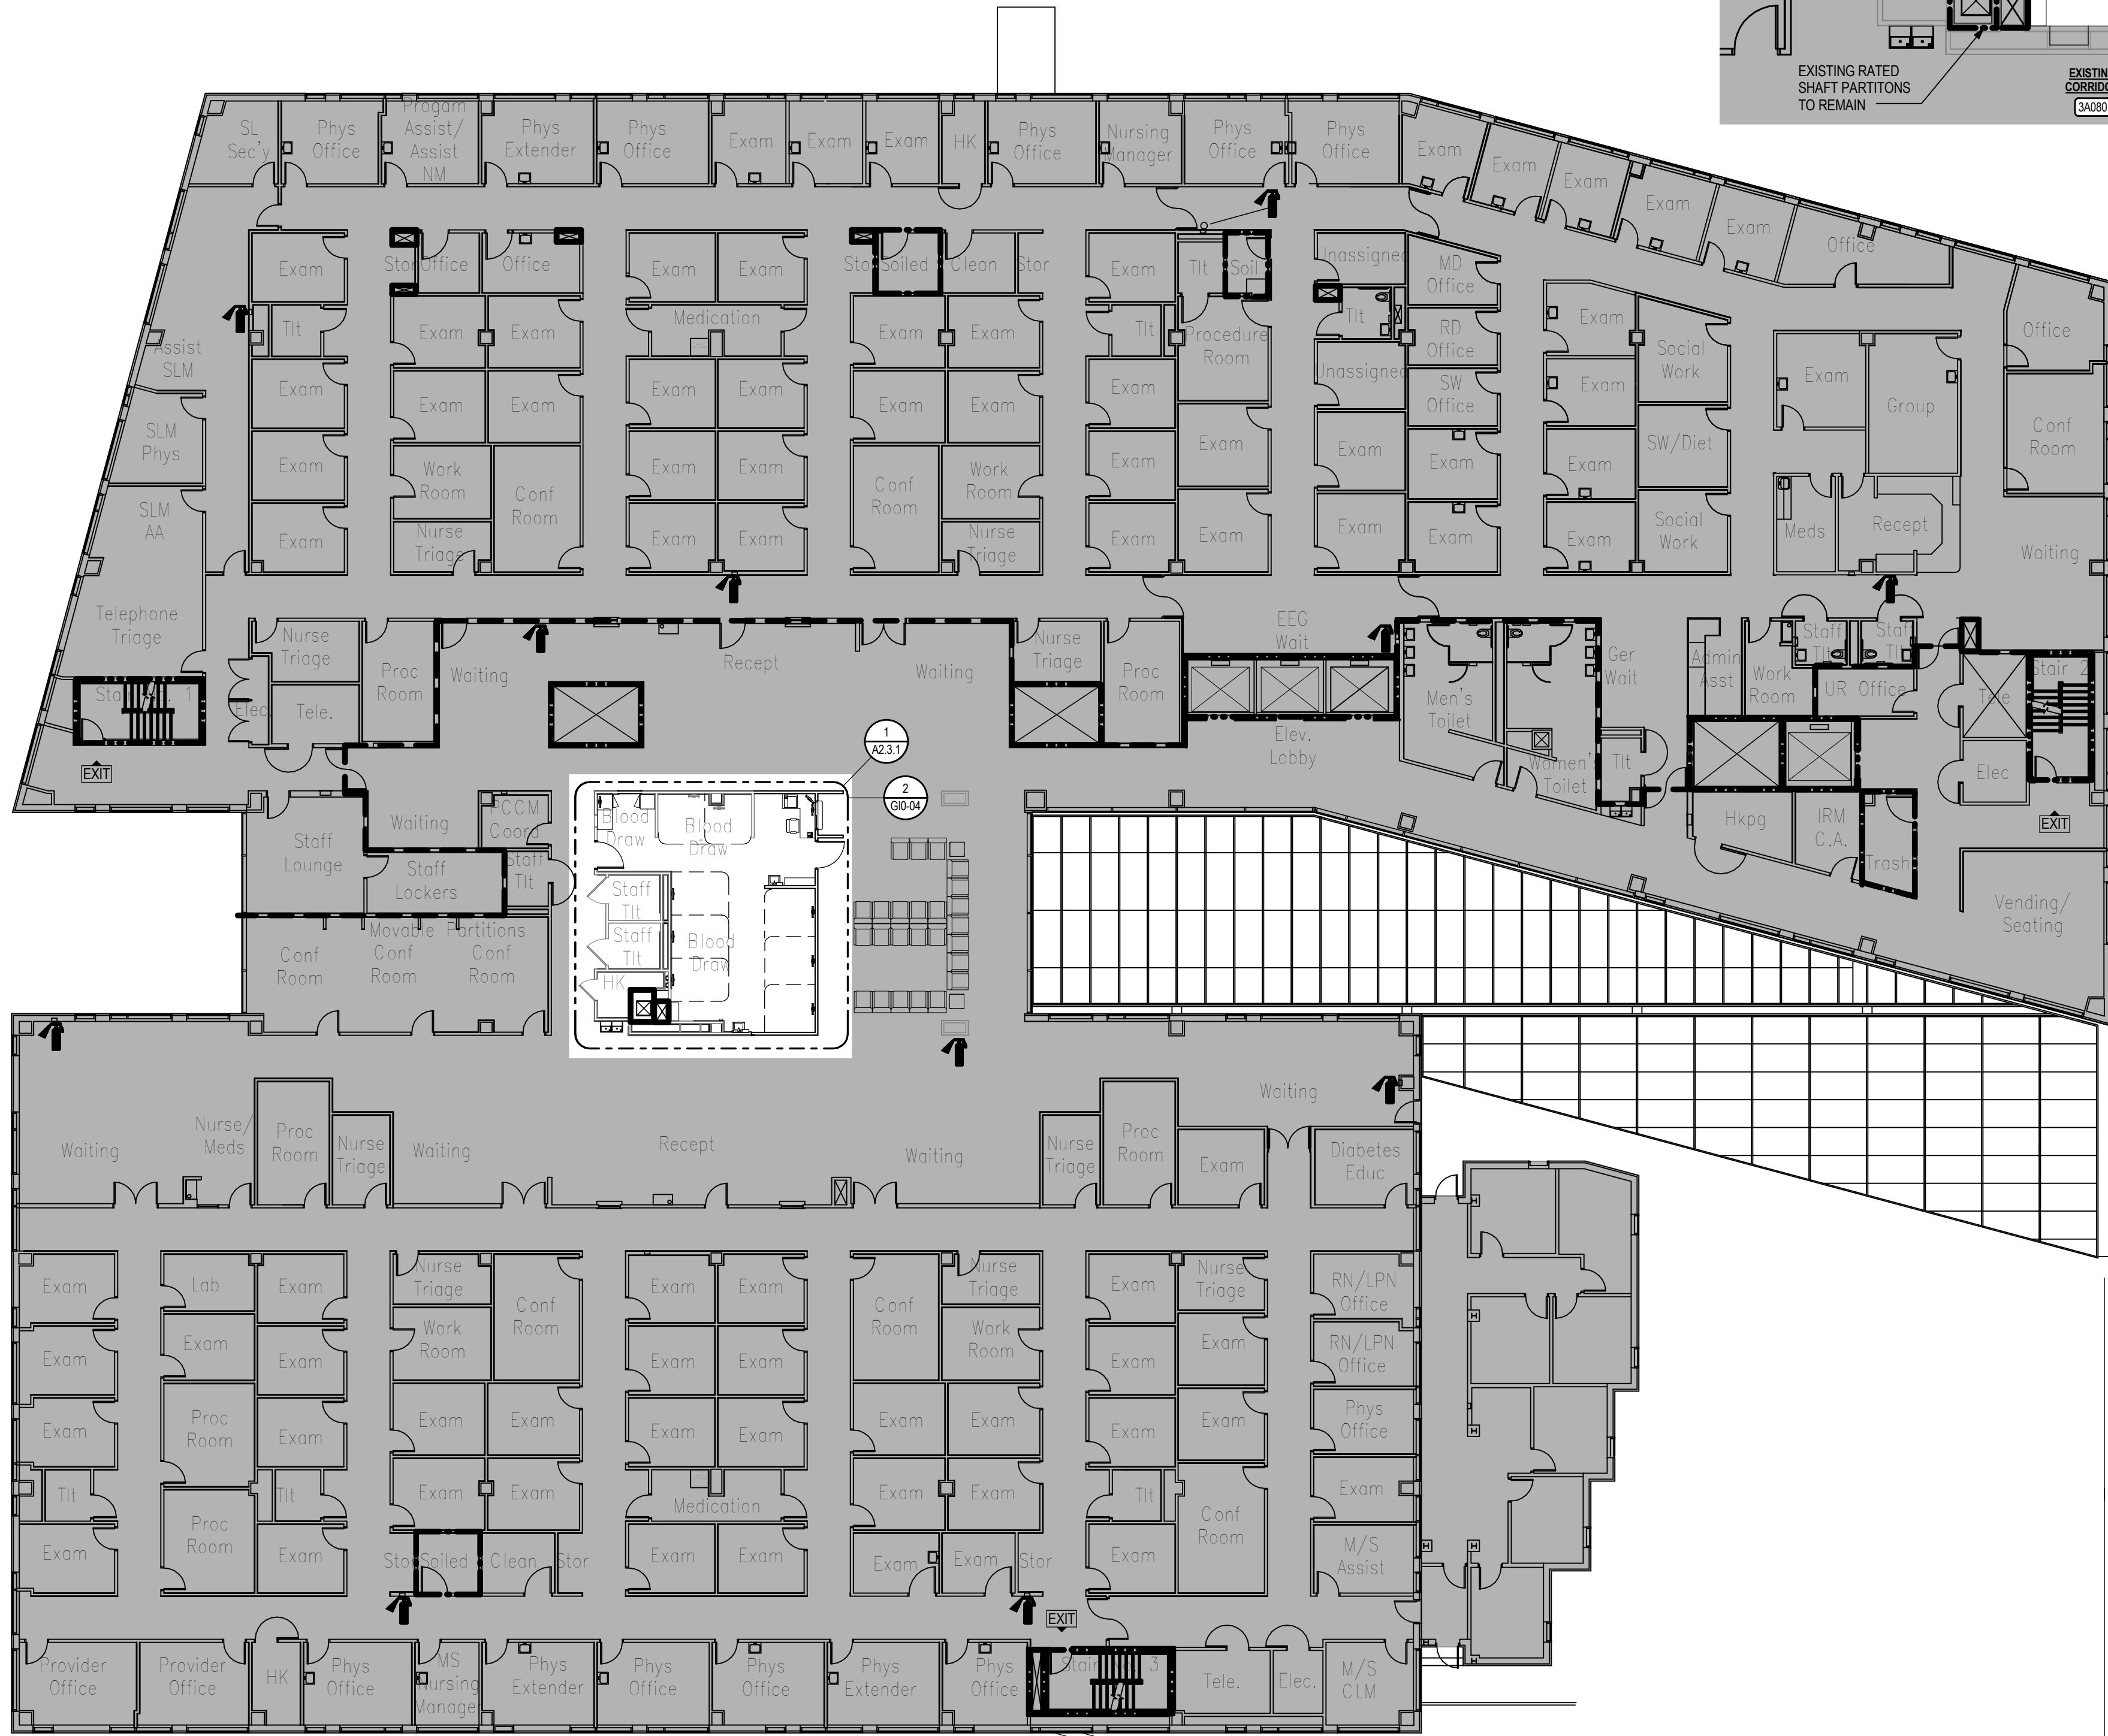


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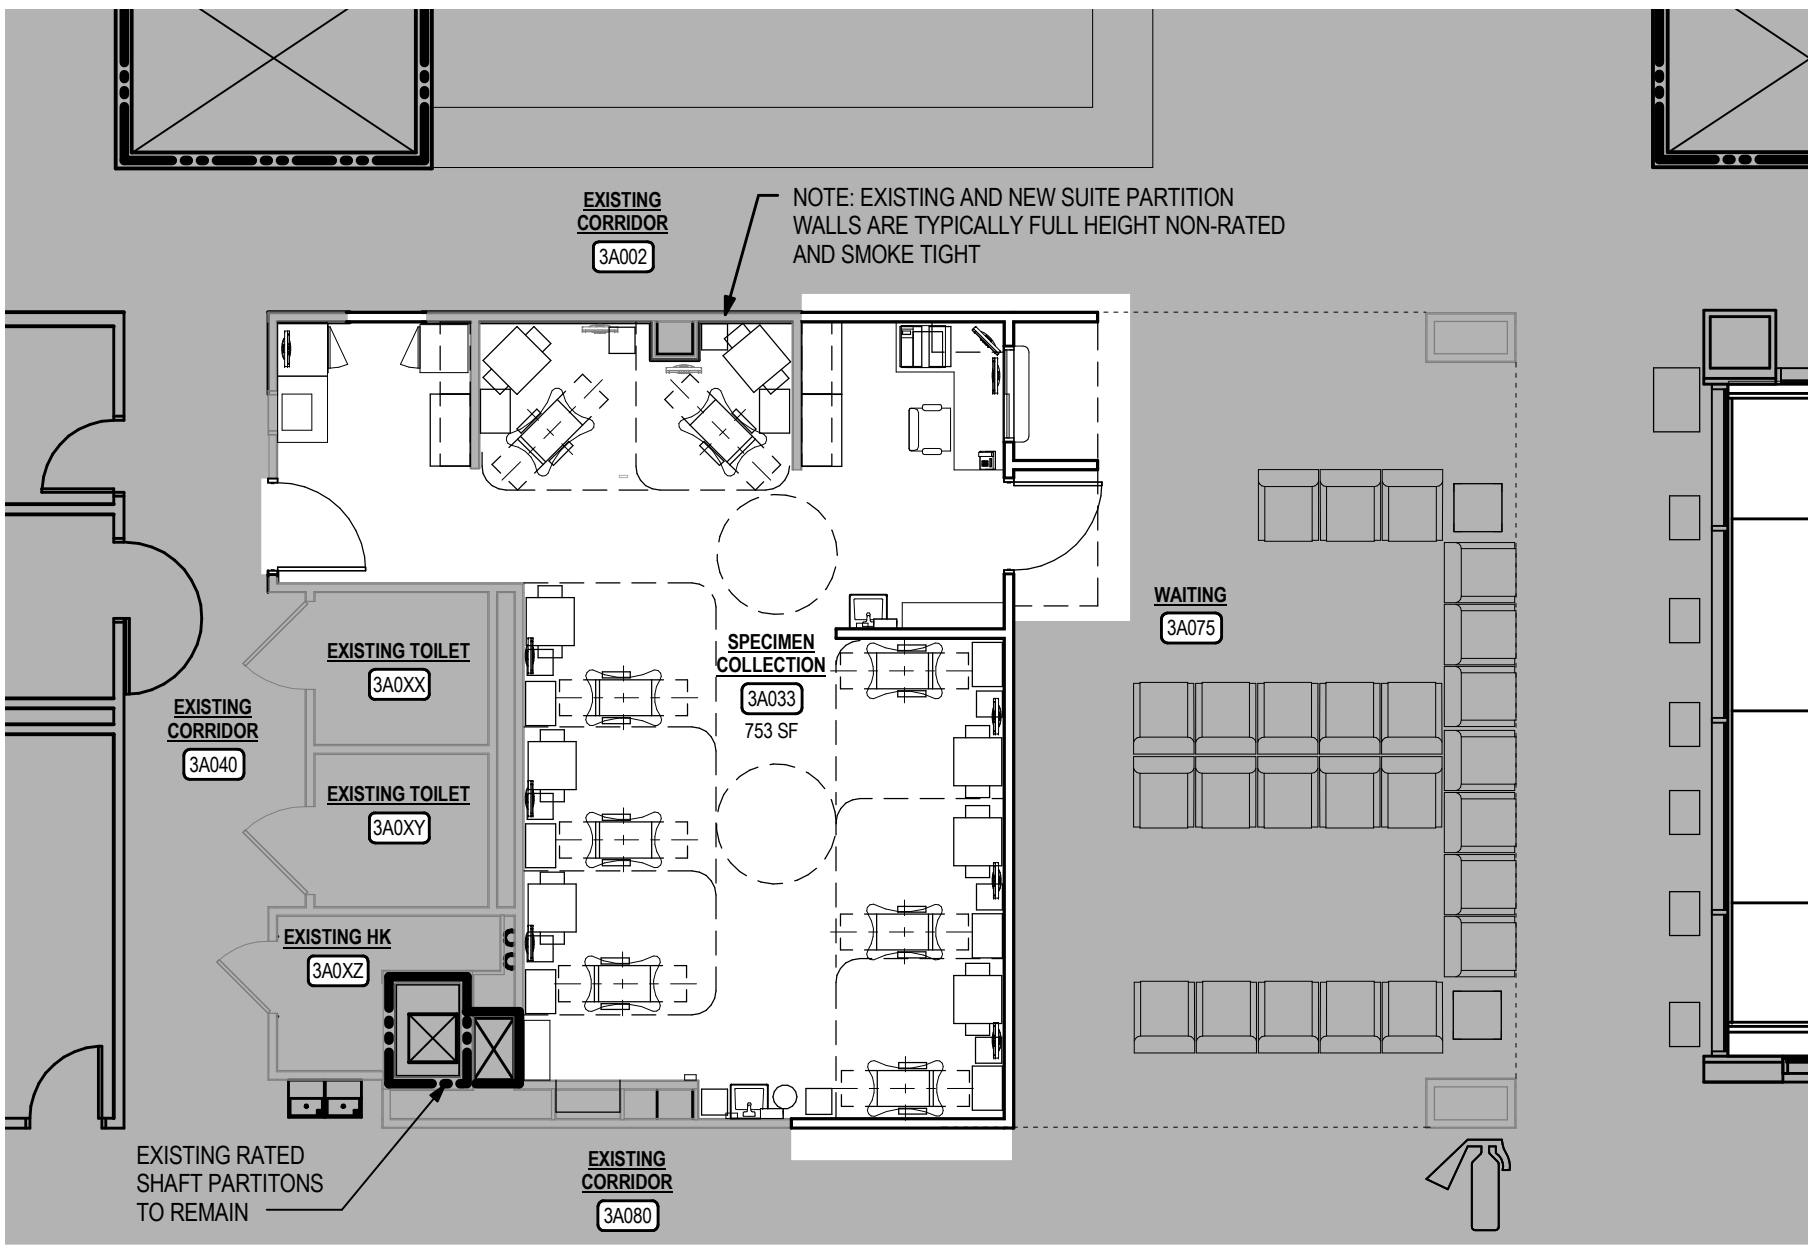
775 Yard Street, Suite 325
Columbus, Ohio 43212
p 614.764.0407
f 614.764.0237
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CONSTRUCTION DOCUMENTS – BID SET						
Drawing Title OVERALL AND PARTIAL THIRD FLOOR LIFE SAFETY PLANS		Project Title Expand Specimen Collection Area		Project Number 757-17-207		Office of Construction and Facilities Management  Columbus VA <small>Chalmers P. Wylie Ambulatory Care Center</small>
				Building Number 1A		
Approved:		Location CHALMERS P. WYLIE VA AMBULATORY CARE CENTER		Drawing Number G10-04		
		Date 10 JULY 2015	Checked By: ds	Drawn By: mrh	 Department of Veterans Affairs	

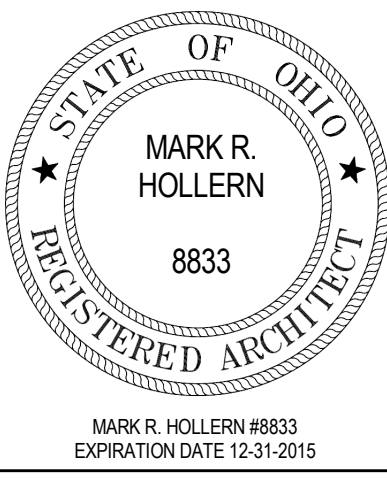

1 third floor - overall plan

NOTE: PARTITION RATINGS NOTED ARE EXISTING CONDITIONS



2 partial third floor - life safety plan

LIFE SAFETY DEVICES LEGEND

- EXIT DOOR (EXG)
- FIRE EXTINGUISHER AND CABINET (EXG)

WALL RATING LEGEND

- 0 HOUR SMOKE/TIGHT PARTITION BUILT TIGHT TO UNDERSIDE OF FLOOR / ROOF DECK ABOVE (EXG)
- SMOKE BARRIER (EXG)
- 1/2 HOUR FIRE BARRIER (EXG)
- ONE-HOUR RATED FIRE BARRIER (EXG)
- TWO-HOUR RATED FIRE BARRIER (EXG)

GENERAL LIFE SAFETY NOTES:

- PROVIDE STENCIL OF WALL RATINGS ON ALL WALLS WITHIN THE LIMITS OF CONSTRUCTION. STENCIL TO BE RED, 3" HIGH LEGIBLE LETTERING, MINIMUM OF 5'-0" O.C. ALONG THE FULL WALL LENGTH, ABOVE CEILING.
- WALL RATINGS SHOWN ON EXISTING WALLS DENOTE EXISTING WALL RATINGS AS PROVIDED BY THE OWNER, WITHIN THE LIMIT OF CONSTRUCTION. REPAIR / FIRE-STOP WALLS TO MEET EXISTING WALL RATINGS.
- REFER TO DOOR SCHEDULE FOR DOOR RATING REQUIREMENTS.
- PATCH EXISTING SPRAY-ON FIREPROOFING DAMAGED DURING CONSTRUCTION TO MATCH EXISTING.

CODE DATA INFORMATION

PROJECT DESCRIPTION:
RENOVATION OF A PORTION OF THE EXISTING THIRD FLOOR PLAN

CODE SUMMARY:
SITE ZONING: EXISTING UNFACTED

BUILDING DESIGN DATA:
- 2012 IBC
- USE GROUP: B - BUSINESS
- CONSTRUCTION TYPE: 1A / NFPA TYPE 1 (442)

TYPE OF WORK PROPOSED:
INTERIOR ALTERATION

AREA OF REMODELED WORK IN THIS PACKAGE: 629 SF

ADDITIONAL APPLICABLE DESIGN CODES:
NFPA 10 STANDARD FOR PORTABLE FIRE EXTINGUISHERS (2013 EDITION)
NFPA 13 FIRE SUPPRESSION (2013 EDITION)
NFPA 70 2014 NEW NATIONAL ELECTRIC CODE
NFPA 72 FIRE ALARM SYSTEM (2010 EDITION)
NFPA 101 LIFE SAFETY CODE (2012 LSC)
ASHRAE 90.1 - 2010
ASHRAE 62.1 - 2010
ANSI A117.1 - 2008 STANDARD ON ACCESSIBLE & USABLE BUILDINGS AND FACILITIES
2010 ADA STANDARDS FOR ACCESSIBLE DESIGN

EXISTING NO. OF EXITS PROVIDED:
MIN EGRESS WIDTH REQD:
NUMBER OF EXITS:

MAXIMUM PATH OF TRAVEL - NOT TO EXCEED 75'-0" (FULLY SPRINKLERED)
EXIT ACCESS - NOT TO EXCEED 300'-0" (FULLY SPRINKLERED)
DEAD END - NOT TO EXCEED 90'-0" (FULLY SPRINKLERED)

FIRE SUPPRESSION AND MONITORING DATA:
FULL FIRE SUPPRESSION: YES EXG
STANDPIPE SYSTEM: YES EXG
MANUAL FIRE ALARM SYSTEM: YES EXG
AUTOMATIC FIRE DETECTION SYSTEM: YES EXG

FIRE RESISTANCE RATING REQUIREMENTS FOR BUILDING ELEMENTS

STRUCTURAL FRAME	
COLUMNS, GIRDERS, TRUSSES	3 HR
BEARING WALLS	
EXTERIOR	3 HR
INTERIOR	3 HR
NON-BEARING WALLS AND PARTITION	
EXTERIOR < 30'	1 HR
EXTERIOR > 30'	0 HR
INTERIOR	0 HR
CORRIDORS	0 HR
FLOOR CONSTRUCTION	
INCLUDING BEAMS, JOISTS	2 HR
ROOF CONSTRUCTION	
INCLUDING SUPPORT AND BEAMS	
LESS THAN 20'	1.5 HR
20' OR MORE	0 HR

ALL ELEMENTS LISTED ABOVE ARE EXISTING TO REMAIN AND DO NOT NECESSARILY COMPLY WITH CURRENT REQUIREMENTS. ANY REQUIRED PATCHING WILL MATCH EXISTING.

SEISMIC ZONE - LOW

DEMOLITION PLAN GENERAL NOTES


- REGARDLESS OF SPECIFIC DEMOLITION NOTED HERE, THE CONTRACTORS SHALL PERFORM ALL DEMOLITION AS REQUIRED FOR NEW CONSTRUCTION.
- REGARDLESS OF SPECIFIC INFORMATION NOTED HERE AND ON NEW WORK PLANS, THE CONTRACTORS SHALL PATCH ANY DEMOLISHED AREAS AS REQUIRED FOR "AS NEW" FINAL APPEARANCE. IF NOT OTHERWISE SPECIFICALLY DIRECTED ON NEW WORK PLANS AND / OR IN THE SPECIFICATIONS, VERIFY FINISH INFORMATION FOR ANY SUCH WORK WITH THE ARCHITECT PRIOR TO STARTING.
- DO NOT DEMOLISH CONCEALED MECHANICAL OR ELECTRICAL SERVICES THAT ARE NOT SPECIFICALLY CALLED OUT FOR DEMOLITION ON THE ENGINEERING DRAWINGS WITHOUT FIRST VERIFYING WITH AND RECEIVING WRITTEN DIRECTION FROM THE ARCHITECT.
- EXISTING FLOORING VARIES - FIELD VERIFY EXISTING CONDITIONS DURING THE PRE-BID WALK THROUGH AGAINST REQUIREMENTS FOR NEW FLOORING SHOWN ON THE NEW WORK / FINISH PLANS. THE EXISTING CONCRETE FLOOR SHALL BE PATCHED / LEVELED / PREPARED AS REQUIRED PRIOR TO INSTALLATION OF NEW FLOORING.
- WHERE INSTALLING NEW WALL FINISH / PROTECTION OR FLOORING, OR WHERE OTHER NEW WORK REQUIRES IT, REMOVE EXISTING-TO-REMAIN MECHANICAL AND ELECTRICAL FIXTURES AND ACCESSORIES. CLEAN AS NECESSARY, AND RE-INSTALL "AS NEW" OVER CONTINUOUS NEW WALL OR FLOOR FINISH.
- WHERE NEW SPRINKLERS ARE BEING INSTALLED, G.C. SHALL DEMOLISH AND PATCH EXISTING HARD CEILINGS AND WALLS AS REQUIRED TO ACCOMMODATE THAT WORK. CONSULT SPRINKLER DRAWINGS AND SPRINKLER CONTRACTOR FOR EXTENT OF REQUIRED WORK.
- SEE SHEET G10-02 FOR LEGEND REGARDING EXISTING TO REMAIN (ETR), EXISTING TO BE DEMOLISHED, AND NEW WORK ITEMS.
- REMOVE EXISTING SLAB AS NECESSARY FOR NEW PLUMBING. SEE PLUMBING DRAWINGS. PATCH FLOOR TO BE LEVEL IN PREPARATION FOR NEW FINISHES.
- SEE FIRE PROTECTION, PLUMBING, MECHANICAL, AND ELECTRICAL DRAWINGS FOR ADDITIONAL DEMOLITION NOTES.
- PROTECT THE FINISH OF THE DESIGNATED CONSTRUCTION ELEVATOR'S FLOOR, CEILING AND WALL SURFACES AND ITS CONTROLS.
- PROTECT THE EXISTING FINISHES ON THE GROUND AND FIRST FLOOR OF THE EXISTING AREAS FROM ANY CONSTRUCTION OR DELIVERIES. REPAIR WITH LIKE MATERIALS IF DAMAGED DURING CONSTRUCTION.
- EXISTING FLOORING = ALL VISIBLE FINISHED FLOORS SUCH AS CARPET AND/OR TILE AND ALL HIDDEN FINISHES UNDER VISIBLE FLOORS SUCH AS TILES UNDER CARPETED AREAS (INCLUDING MULTIPLE LAYERS). REMOVE ALL EXISTING FLOOR FINISHES DOWN TO THE CONCRETE FLOOR SLAB.
- OWNER TO REMOVE ALL FURNITURE, ARTWORK AND MOVABLE EQUIPMENT PRIOR TO THE START OF CONSTRUCTION.
- CONTRACTOR IS RESPONSIBLE TO REMOVE ALL REMAINING WALL HUNG ITEMS, INCLUDING TOILET ACCESSORIES, MIRRORS, MARKERBOARDS, TACKBOARDS, CHALKBOARDS, PROJECTION SCREENS, FIRE EXTINGUISHER CABINETS, FIRE EXTINGUISHERS, WINDOW BLINDS, ROOM SIGNS, ETC.
- PATCH ALL RATED PARTITION WALLS TO REMAIN IN PROJECT AREA. FIRE STOP ANY OPENINGS IN PARTITIONS. SEE LIFE SAFETY DRAWINGS FOR RATED PARTITIONS.
- SEE PROJECT MANUAL FOR REQUIREMENTS REGARDING DUST CONTROL, INCLUDING TEMPORARY DUST PARTITIONS, AND THE PROTECTION OF SMOKE DETECTORS. SEE FIRE PROTECTION NOTES.
- SEE PHASING DRAWINGS TO COORDINATE WORK NEXT TO AREAS REMAINING IN OPERATION DURING CONSTRUCTION.

DEMOLITION CODED NOTES


- D1 EXISTING TO REMAIN
- D2 REMOVE PORTION OF EXISTING PARTITION WALL.
- D3 REMOVE DOOR, FRAME AND HARDWARE. SALVAGE HARDWARE TO REINSTALL PER NEW WORK PLAN.
- D4 REMOVE EXISTING CORNER GUARD. SALVAGE TO REINSTALL.
- D5 REMOVE EXISTING BORROWED LITE WINDOW AND FRAME.
- D6 OWNER TO REMOVE EXISTING COUNTERS AND WALL MOUNTED RAILS BEFORE CONSTRUCTION.
- D7 OWNER TO REMOVE EXISTING WALL HUNG FLIPPER DOOR CABINETS AND WALL RAILS.
- D8 REMOVE EXISTING WALL SINK. SEE PLUMBING DRAWINGS.
- D9 REMOVE EXISTING EYE WASH. SEE PLUMBING DRAWINGS.
- D10 REMOVE EXISTING PC WALL BRACKETS. SALVAGE AND REINSTALL PER NEW WORK PLAN.
- D11 REMOVE EXISTING TV WALL MOUNTING BRACKET.
- D12 EXISTING PC WALL MONITOR TO REMAIN.
- D13 REMOVE EXISTING FLOORING AND INTEGRAL ROOM BASE FROM ROOM.
- D14 EXISTING WINDOW TO REMAIN.
- D15 REMOVE PORTION OF EXISTING FLOORING AND PREP FOR NEW FLOORING.
- D16 REMOVE PORTION OF EXISTING CEILING FOR NEW CEILING.
- D17 OWNER TO REMOVE EXISTING WALL MOUNTED DISPLAY BOARDS ON THIS PARTITION WALL PRIOR TO DEMOLITION OF WALL BY CONTRACTOR.
- D18 MODIFY END OF EXISTING HANDRAIL TO EXTEND PER NEW WORK PLAN.
- D19 REMOVE PORTIONS OF EXISTING CEILINGS IN CORRIDORS AND ROOMS FROM THE MAIN WORK AREA TO THE ELECTRICAL AND DATA CLOSETS IDENTIFIED ON THE ELECTRICAL DRAWINGS. REPLACE REMOVED PORTIONS OF CEILINGS TO MATCH EXISTING.
- D20 LOCATION OF NEW OR EXISTING PLUMBING ABOVE. SEE PLUMBING DRAWINGS. SLEEVE PENETRATIONS THROUGH FLOOR ABOVE AND INSTALL FIRE STOPPING. REMOVE PORTIONS OF EXISTING CEILINGS IN AREAS BELOW ON THE THIRD FLOOR TO ACCESS FOR PLUMBING MODIFICATIONS. REPLACER/REPAINT TO MATCH EXISTING TO BE LIKE NEW.
- D21 REMOVE EXISTING COAT HOOKS. SALVAGE AND REINSTALL PER NEW WORK PLAN.
- D22 EXISTING COAT HOOKS TO REMAIN.
- D23 REMOVE ROOM BASE.
- D24 REMOVE EXISTING HANDRAIL AND MOUNTING BRACKETS. SALVAGE TO REINSTALL PER NEW WORK PLAN.
- D25 REMOVE EXISTING LIGHT FIXTURE. SALVAGE. SEE ELECTRICAL DRAWINGS AND SPECIFICATIONS.
- D26 EXISTING LIGHT FIXTURE TO REMAIN. SEE ELECTRICAL DRAWINGS.
- D27 REMOVE EXISTING COVE LIGHT FIXTURE. SALVAGE AND REINSTALL PER NEW WORK PLAN ON ELECTRICAL DRAWINGS.
- D28 REMOVE EXISTING CUBICLE CURTAIN TRACK.
- D29 EXISTING CUBICLE CURTAIN TRACK TO REMAIN.
- D30 EXISTING CEILING TO REMAIN. MODIFY AT MODIFIED PARTITION WALLS AND AT RELOCATED CEILING DEVICES. SEE NEW WORK PLANS.
- D31 REMOVE PORTION OF EXISTING WALLBOARD HEADER FOR NEW WALL PARTITION.
- D32 REMOVE EXISTING PAPER TOWEL DISPENSER, SOAP DISPENSER, ALCOHOL HAND DISPENSER AND POP-UP SAFETY ZONE DISPENSER. SALVAGE AND REINSTALL PER NEW WORK PLAN.
- D33 REMOVE EXISTING ALCOHOL HAND DISPENSER. REINSTALL PER NEW WORK PLAN.
- D34 EXISTING SIGNAGE TO BE REMOVED BY OWNER.

LEGEND


- ACT - EXISTING ACOUSTICAL LAY-IN CEILING TILE
REMOVE AND REINSTALL AS NECESSARY TO INSTALL NEW PLUMBING ABOVE.
REPLACE ANY BROKEN OR DAMAGED CEILING TILES.
- GB - EXISTING GYPSUM BOARD CEILING
REMOVE PORTION OF CEILING AS NECESSARY TO INSTALL NEW PLUMBING ABOVE.
REPAIR WALLBOARD CEILING WITH LIKE MATERIALS. REPAINT ENTIRE ROOM
CEILING TO MATCH EXISTING.

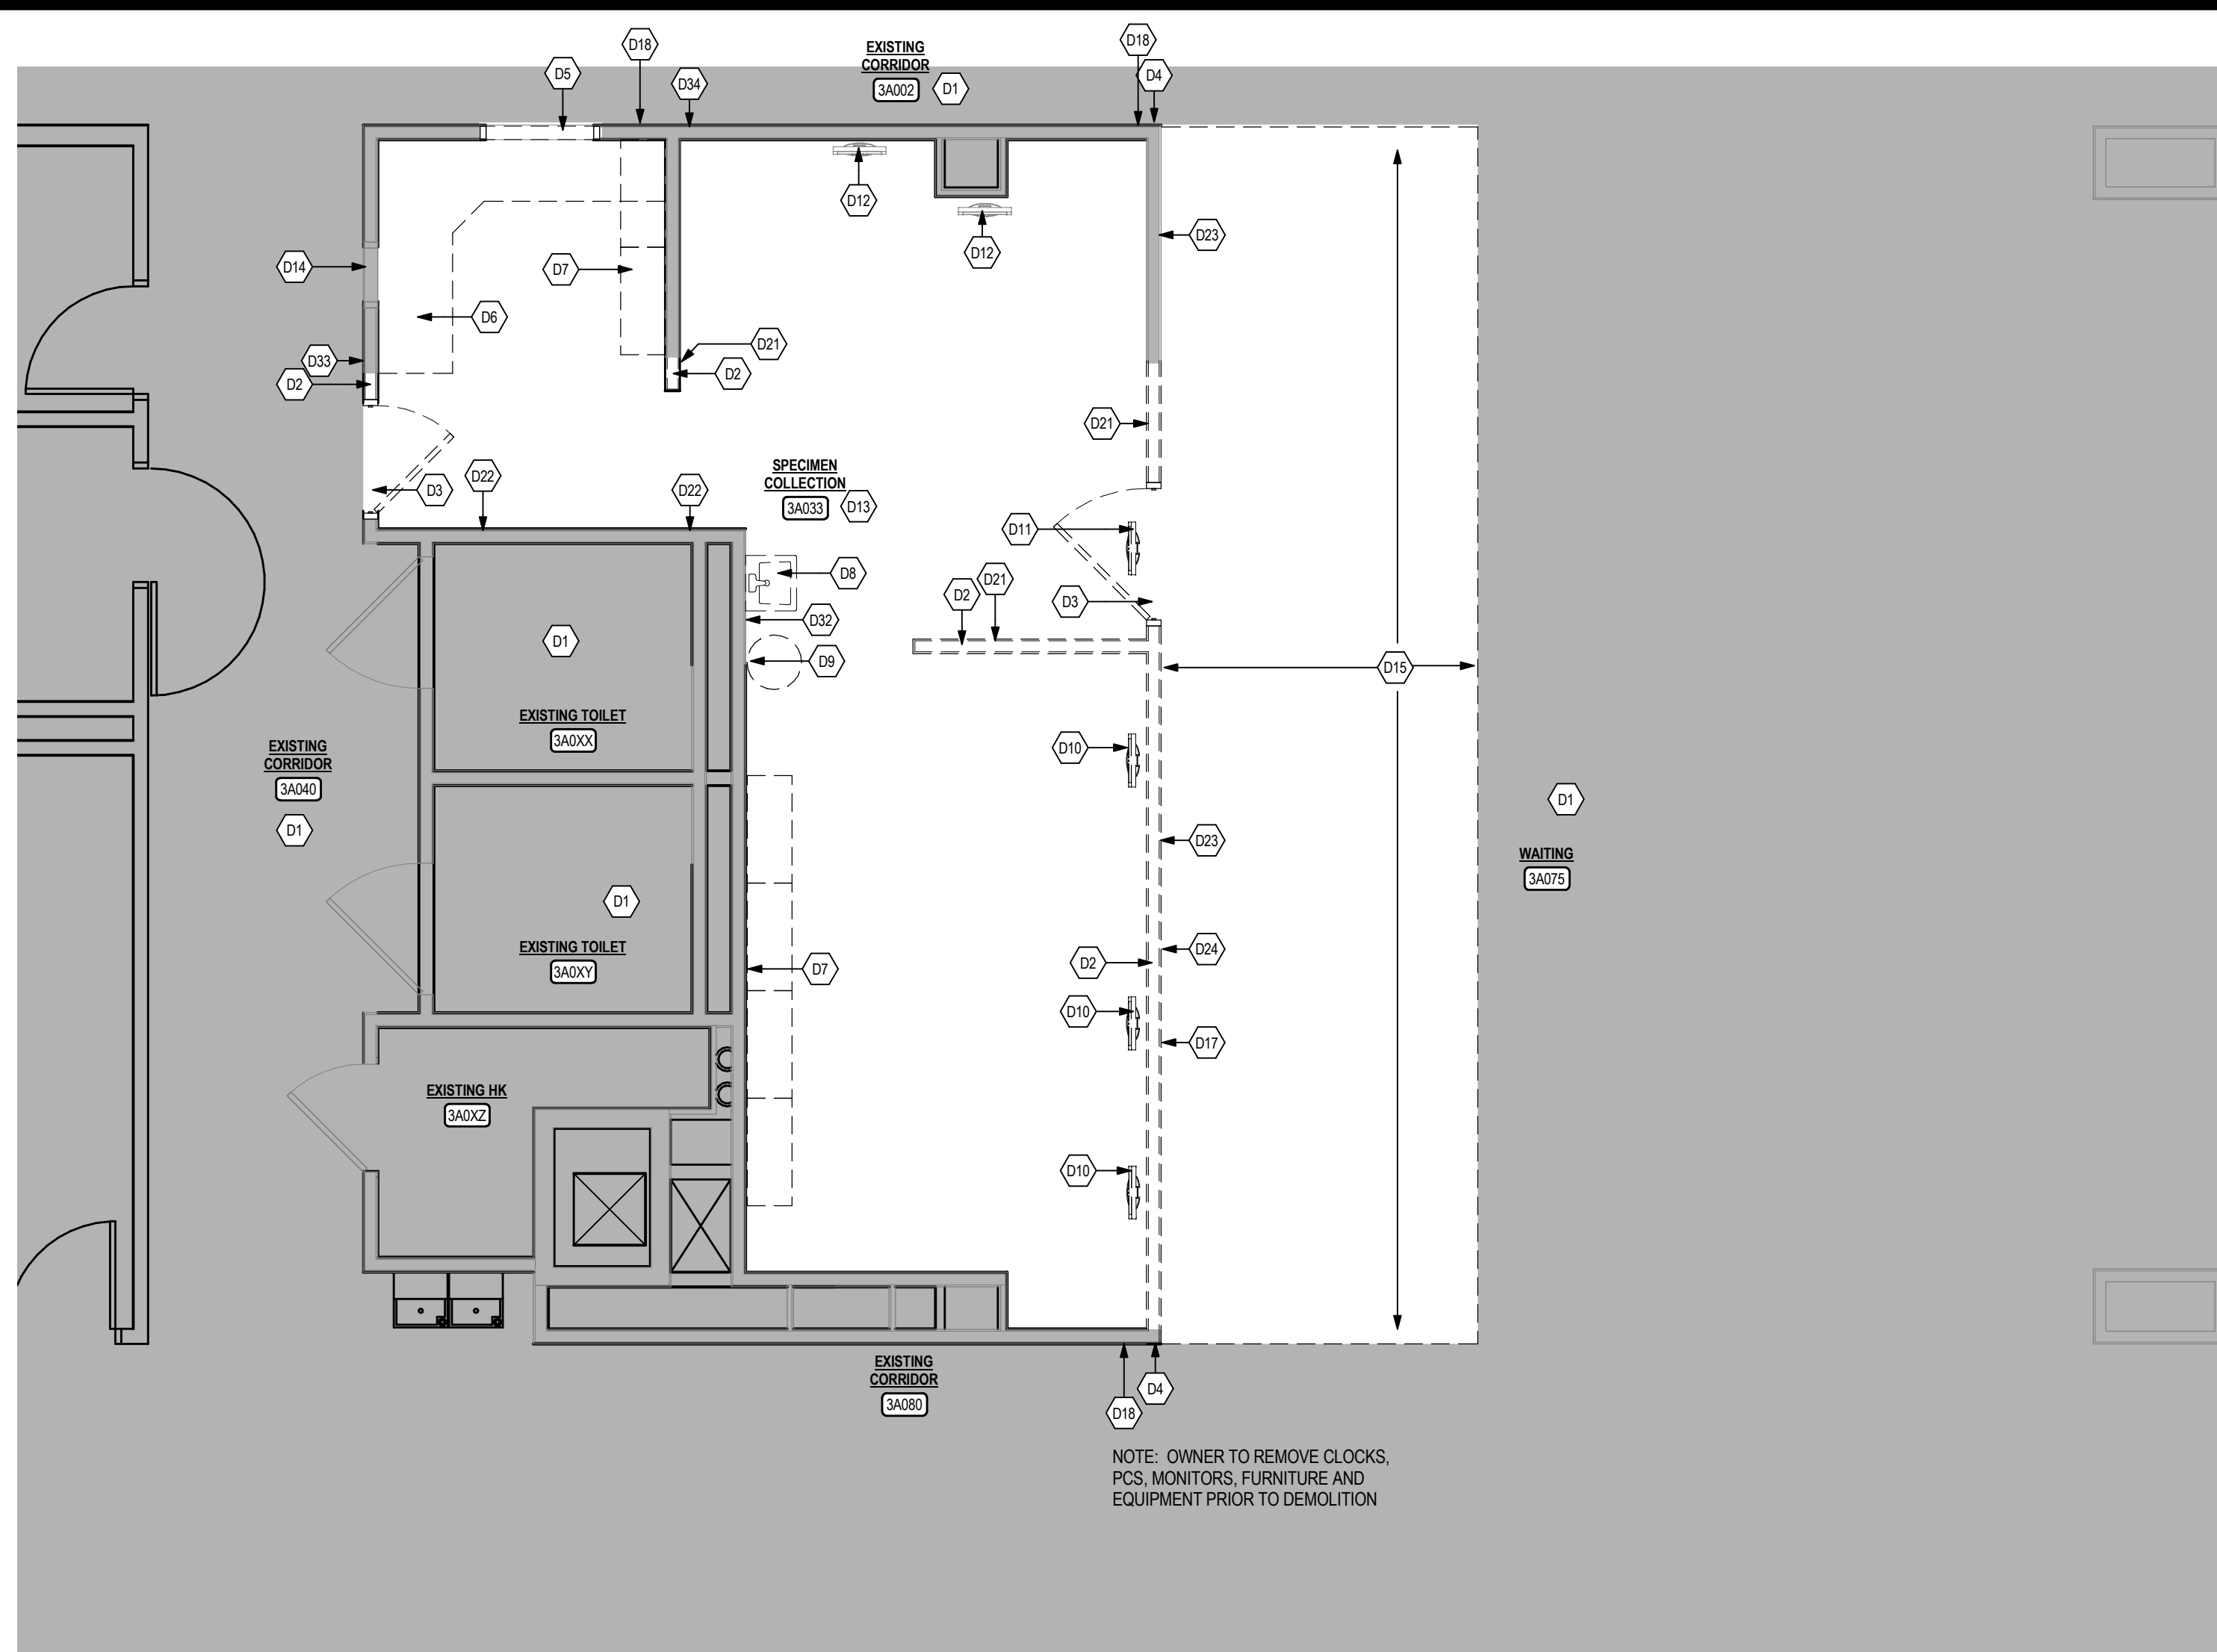

1 partial third floor - demolition plan
A1.3.1 1/4" = 1'-0"

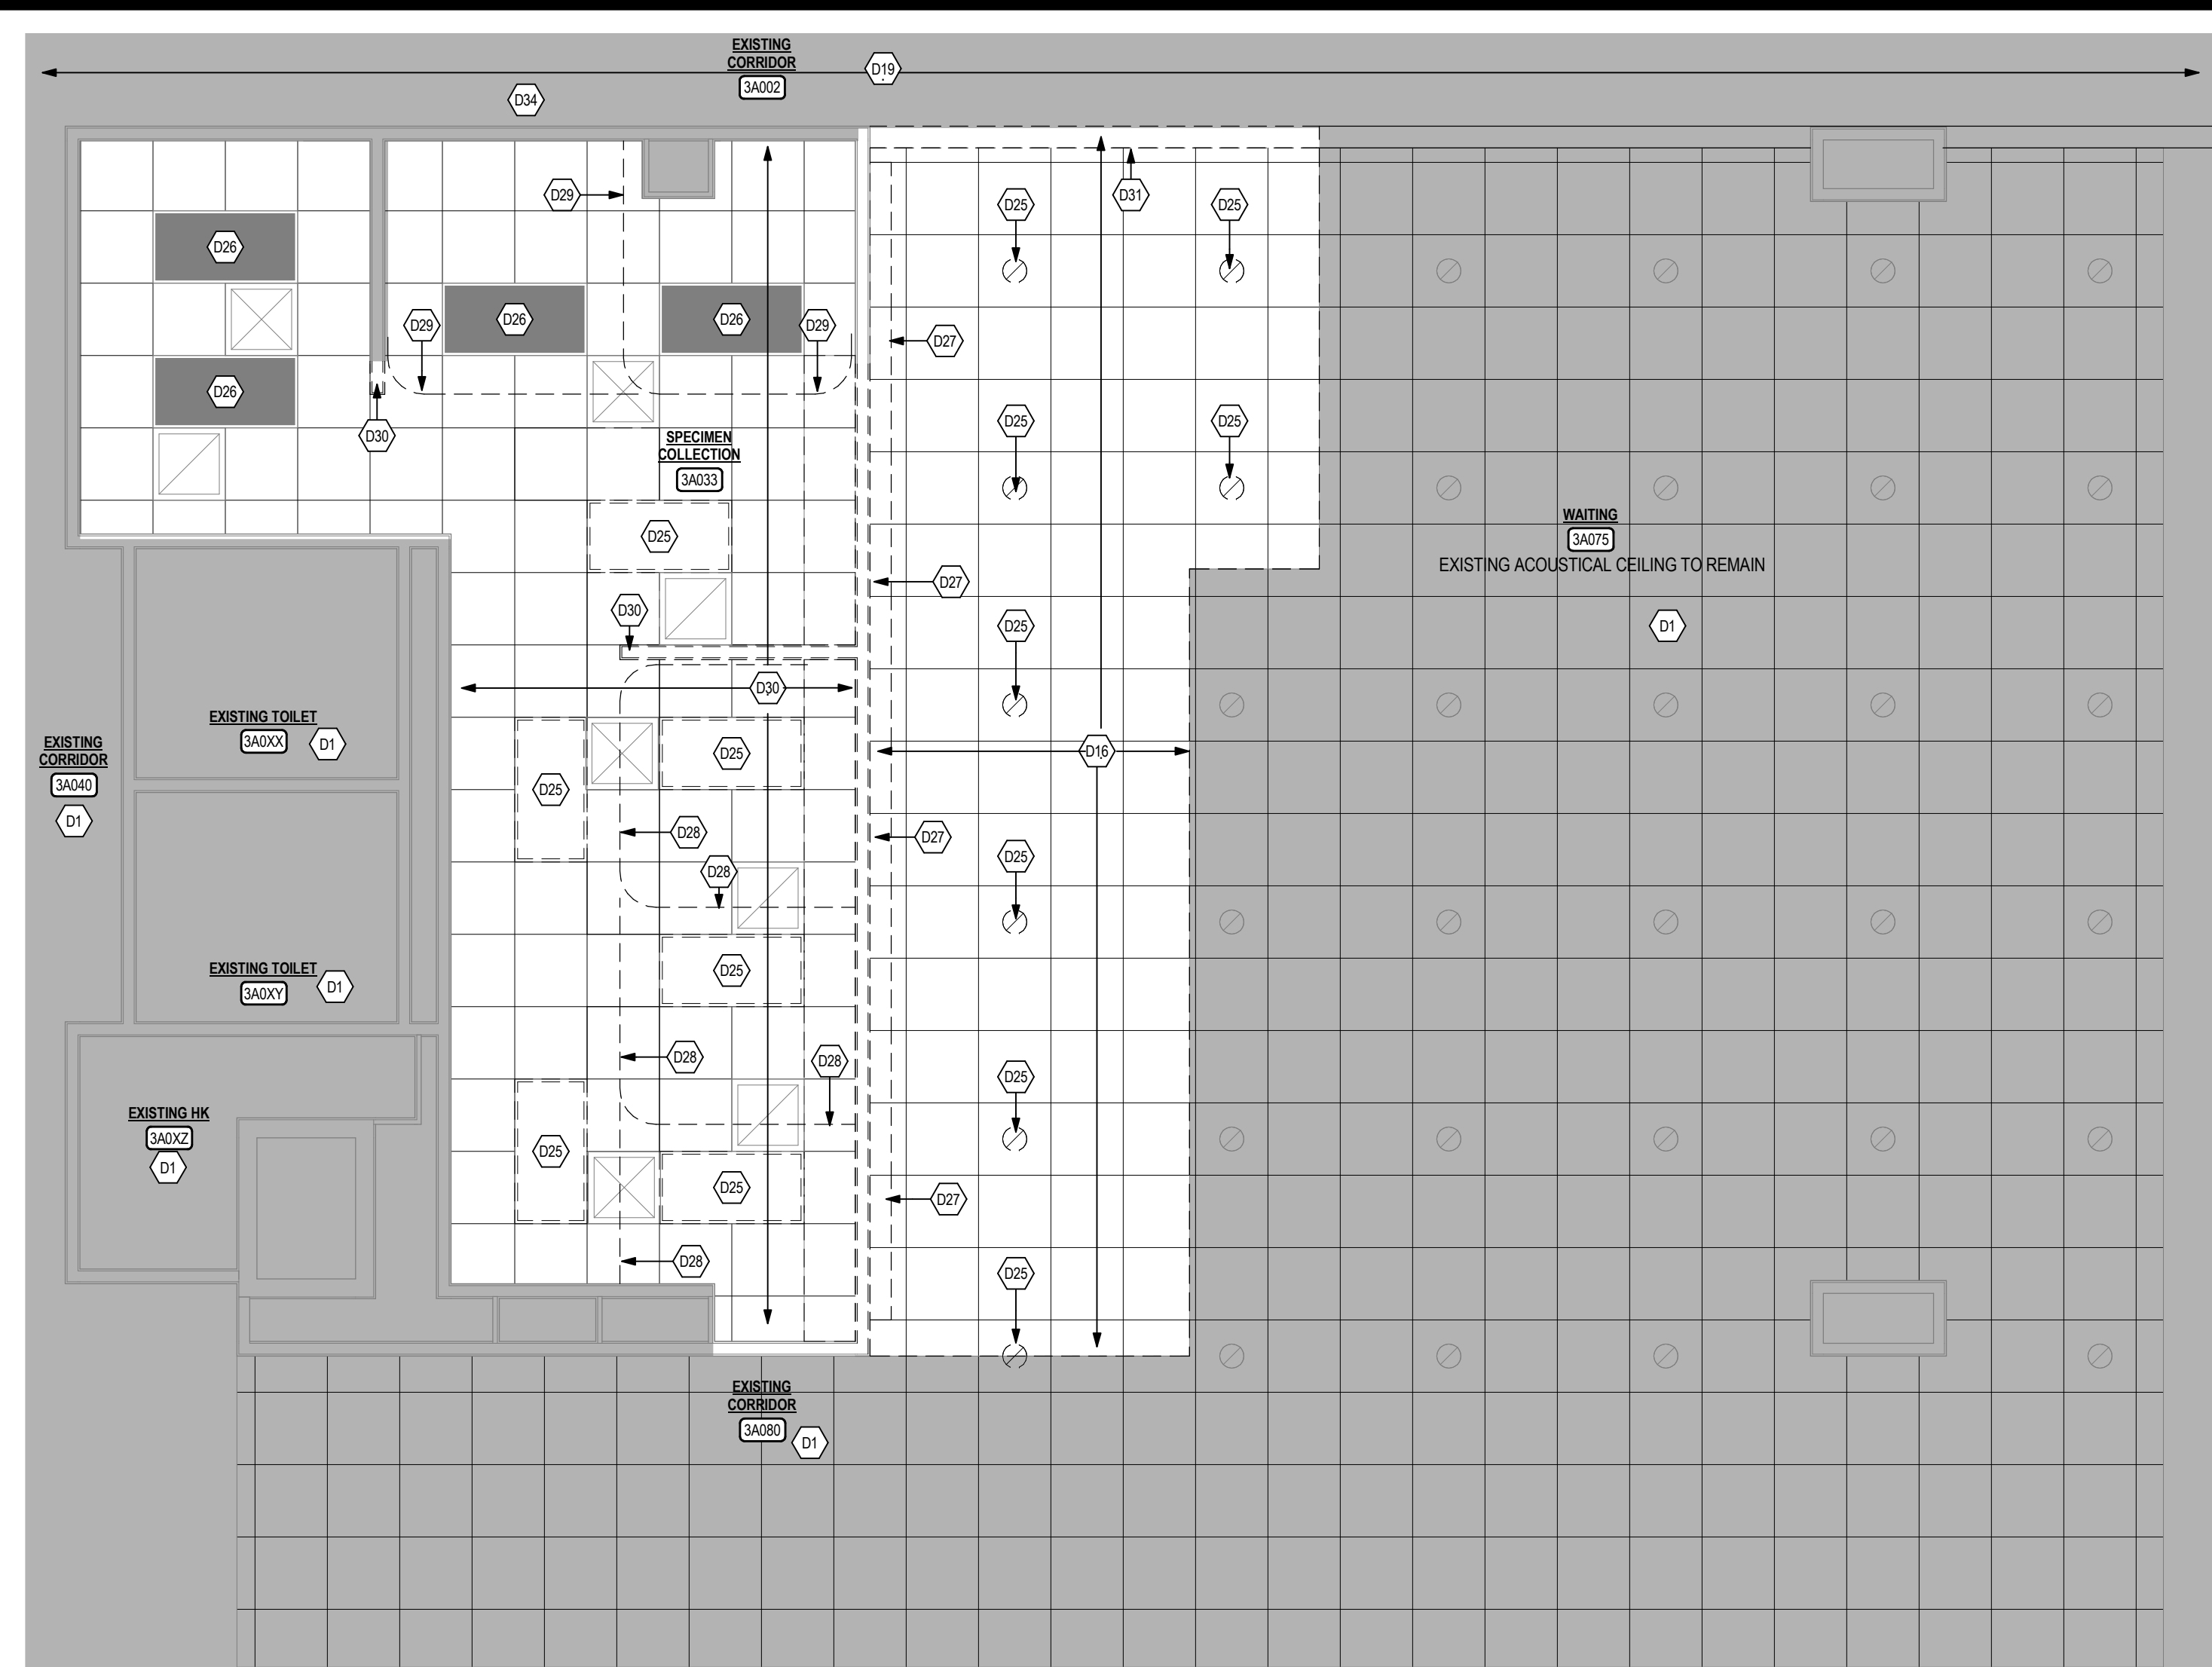

2 partial third floor - rcp demolition plan
A1.3.1 1/4" = 1'-0"

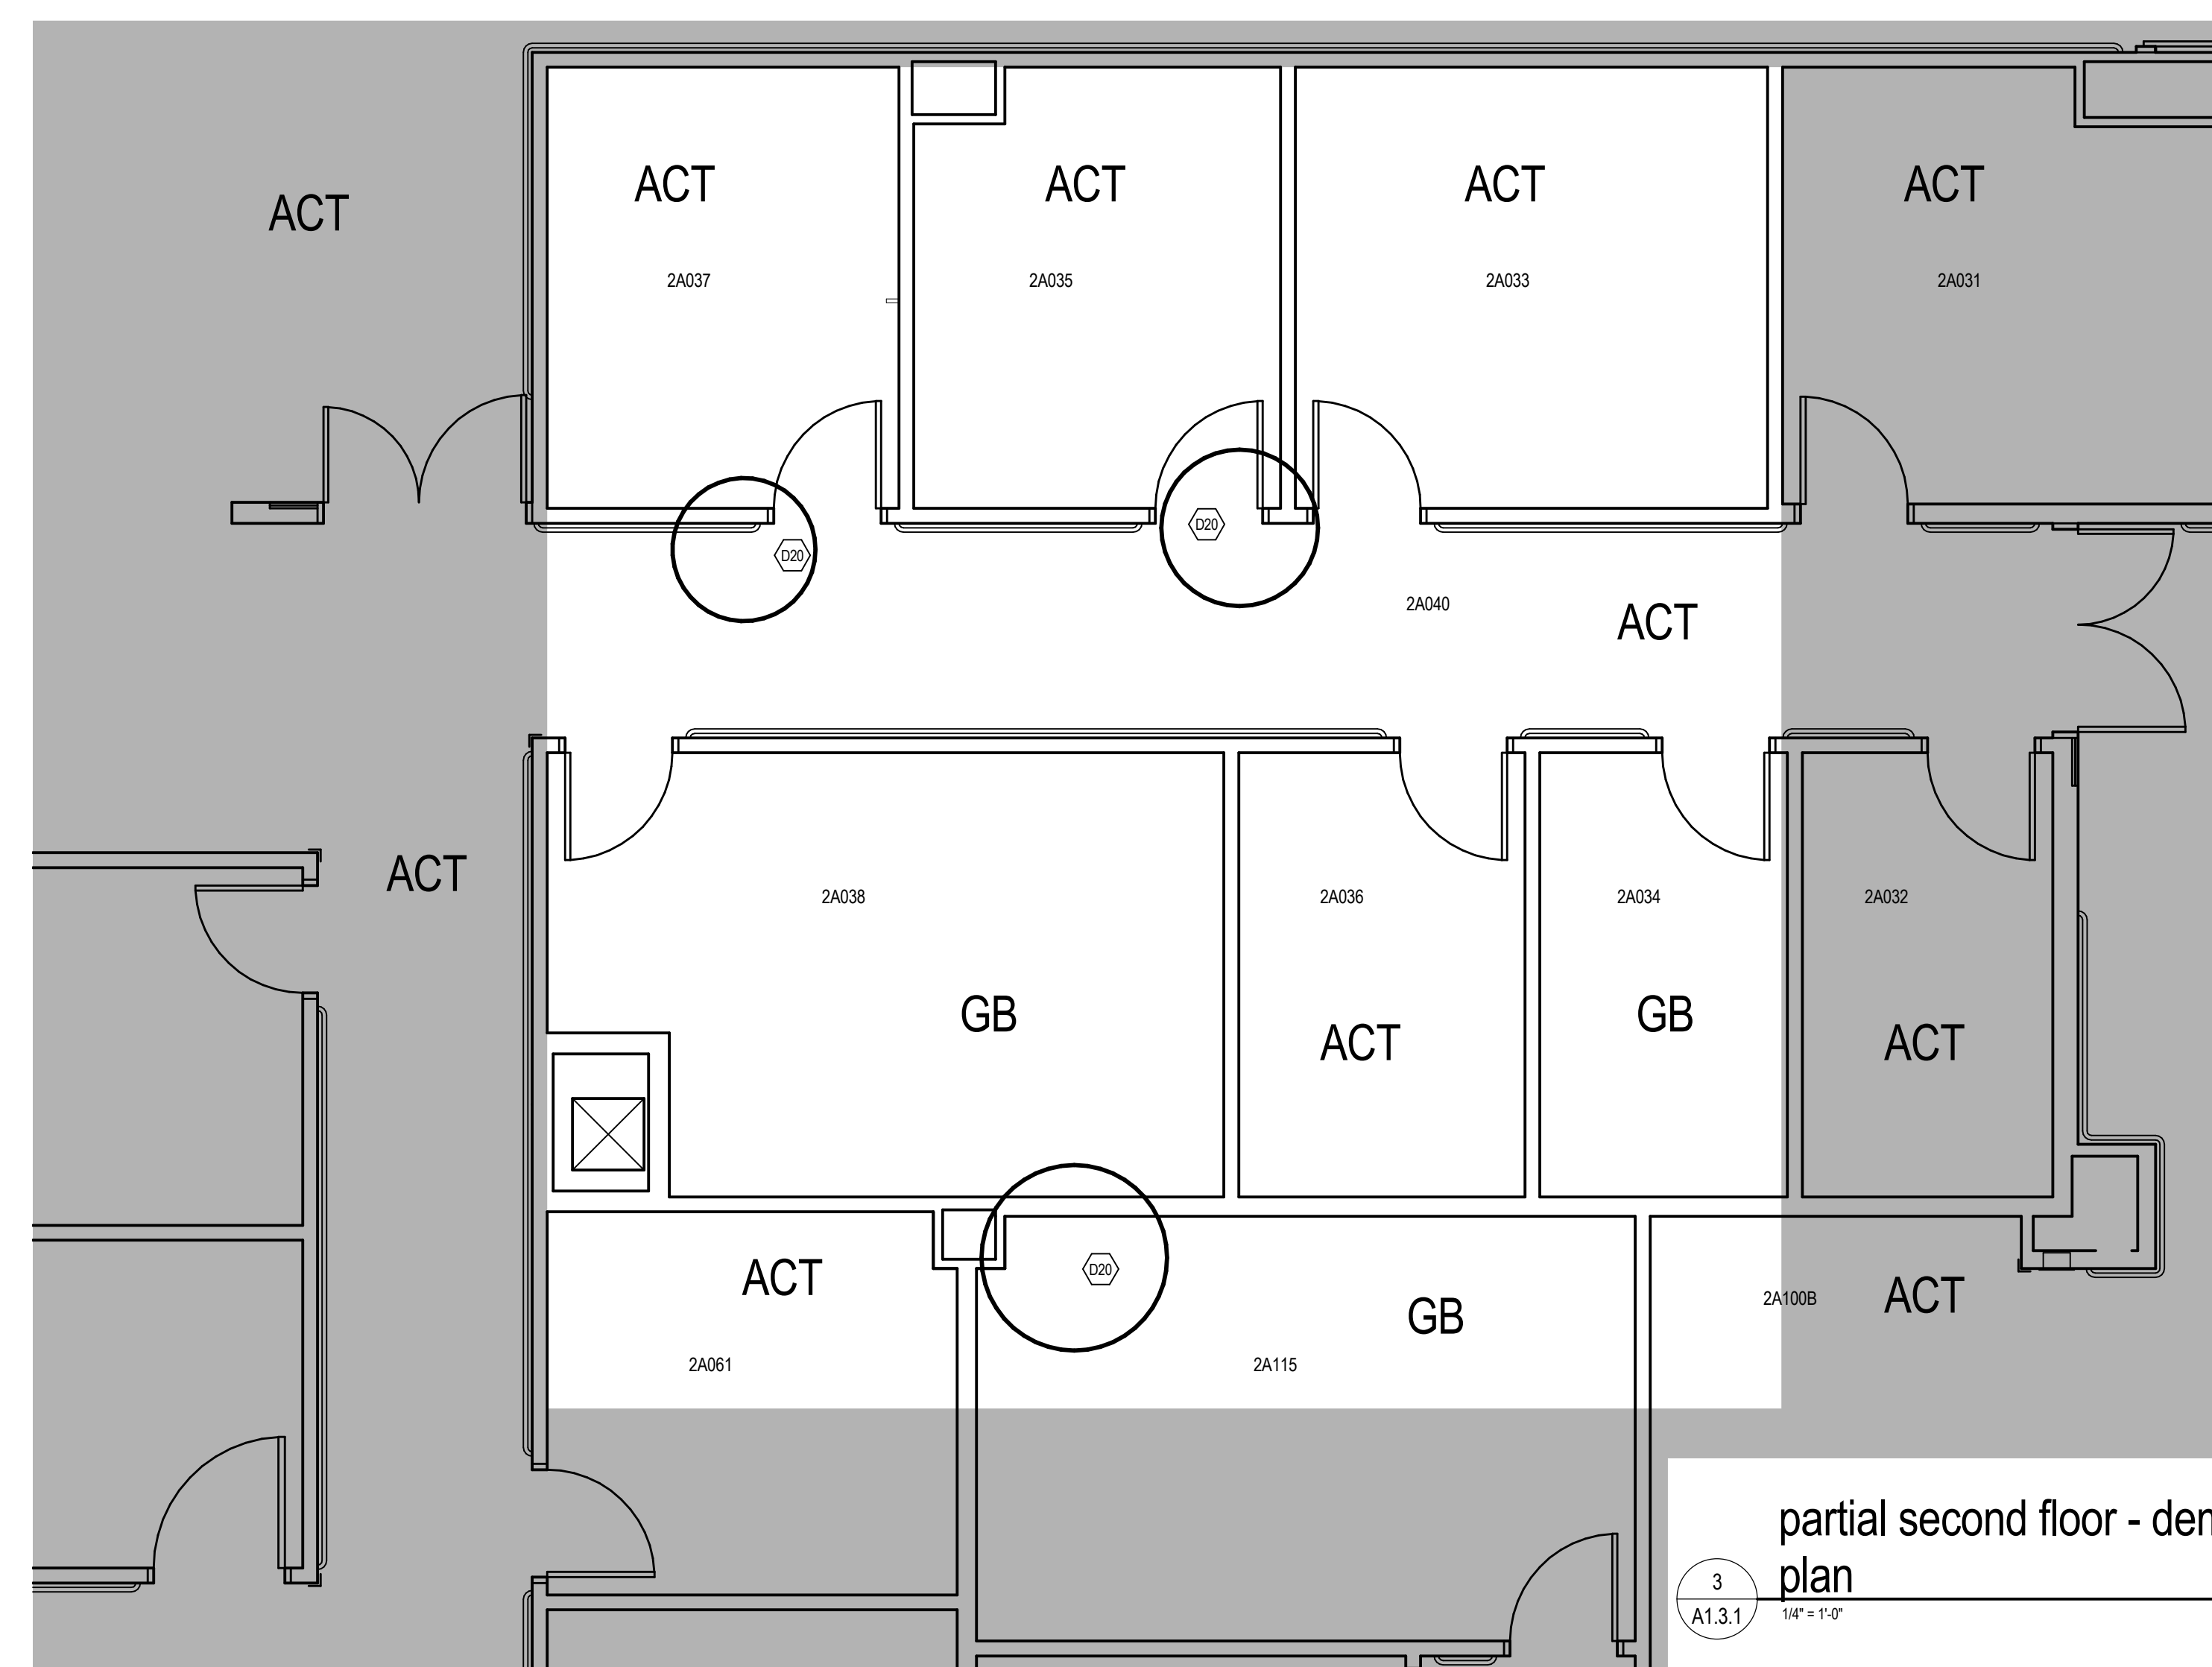


3 partial second floor - demolition plan
A1.3.1 1/4" = 1'-0"

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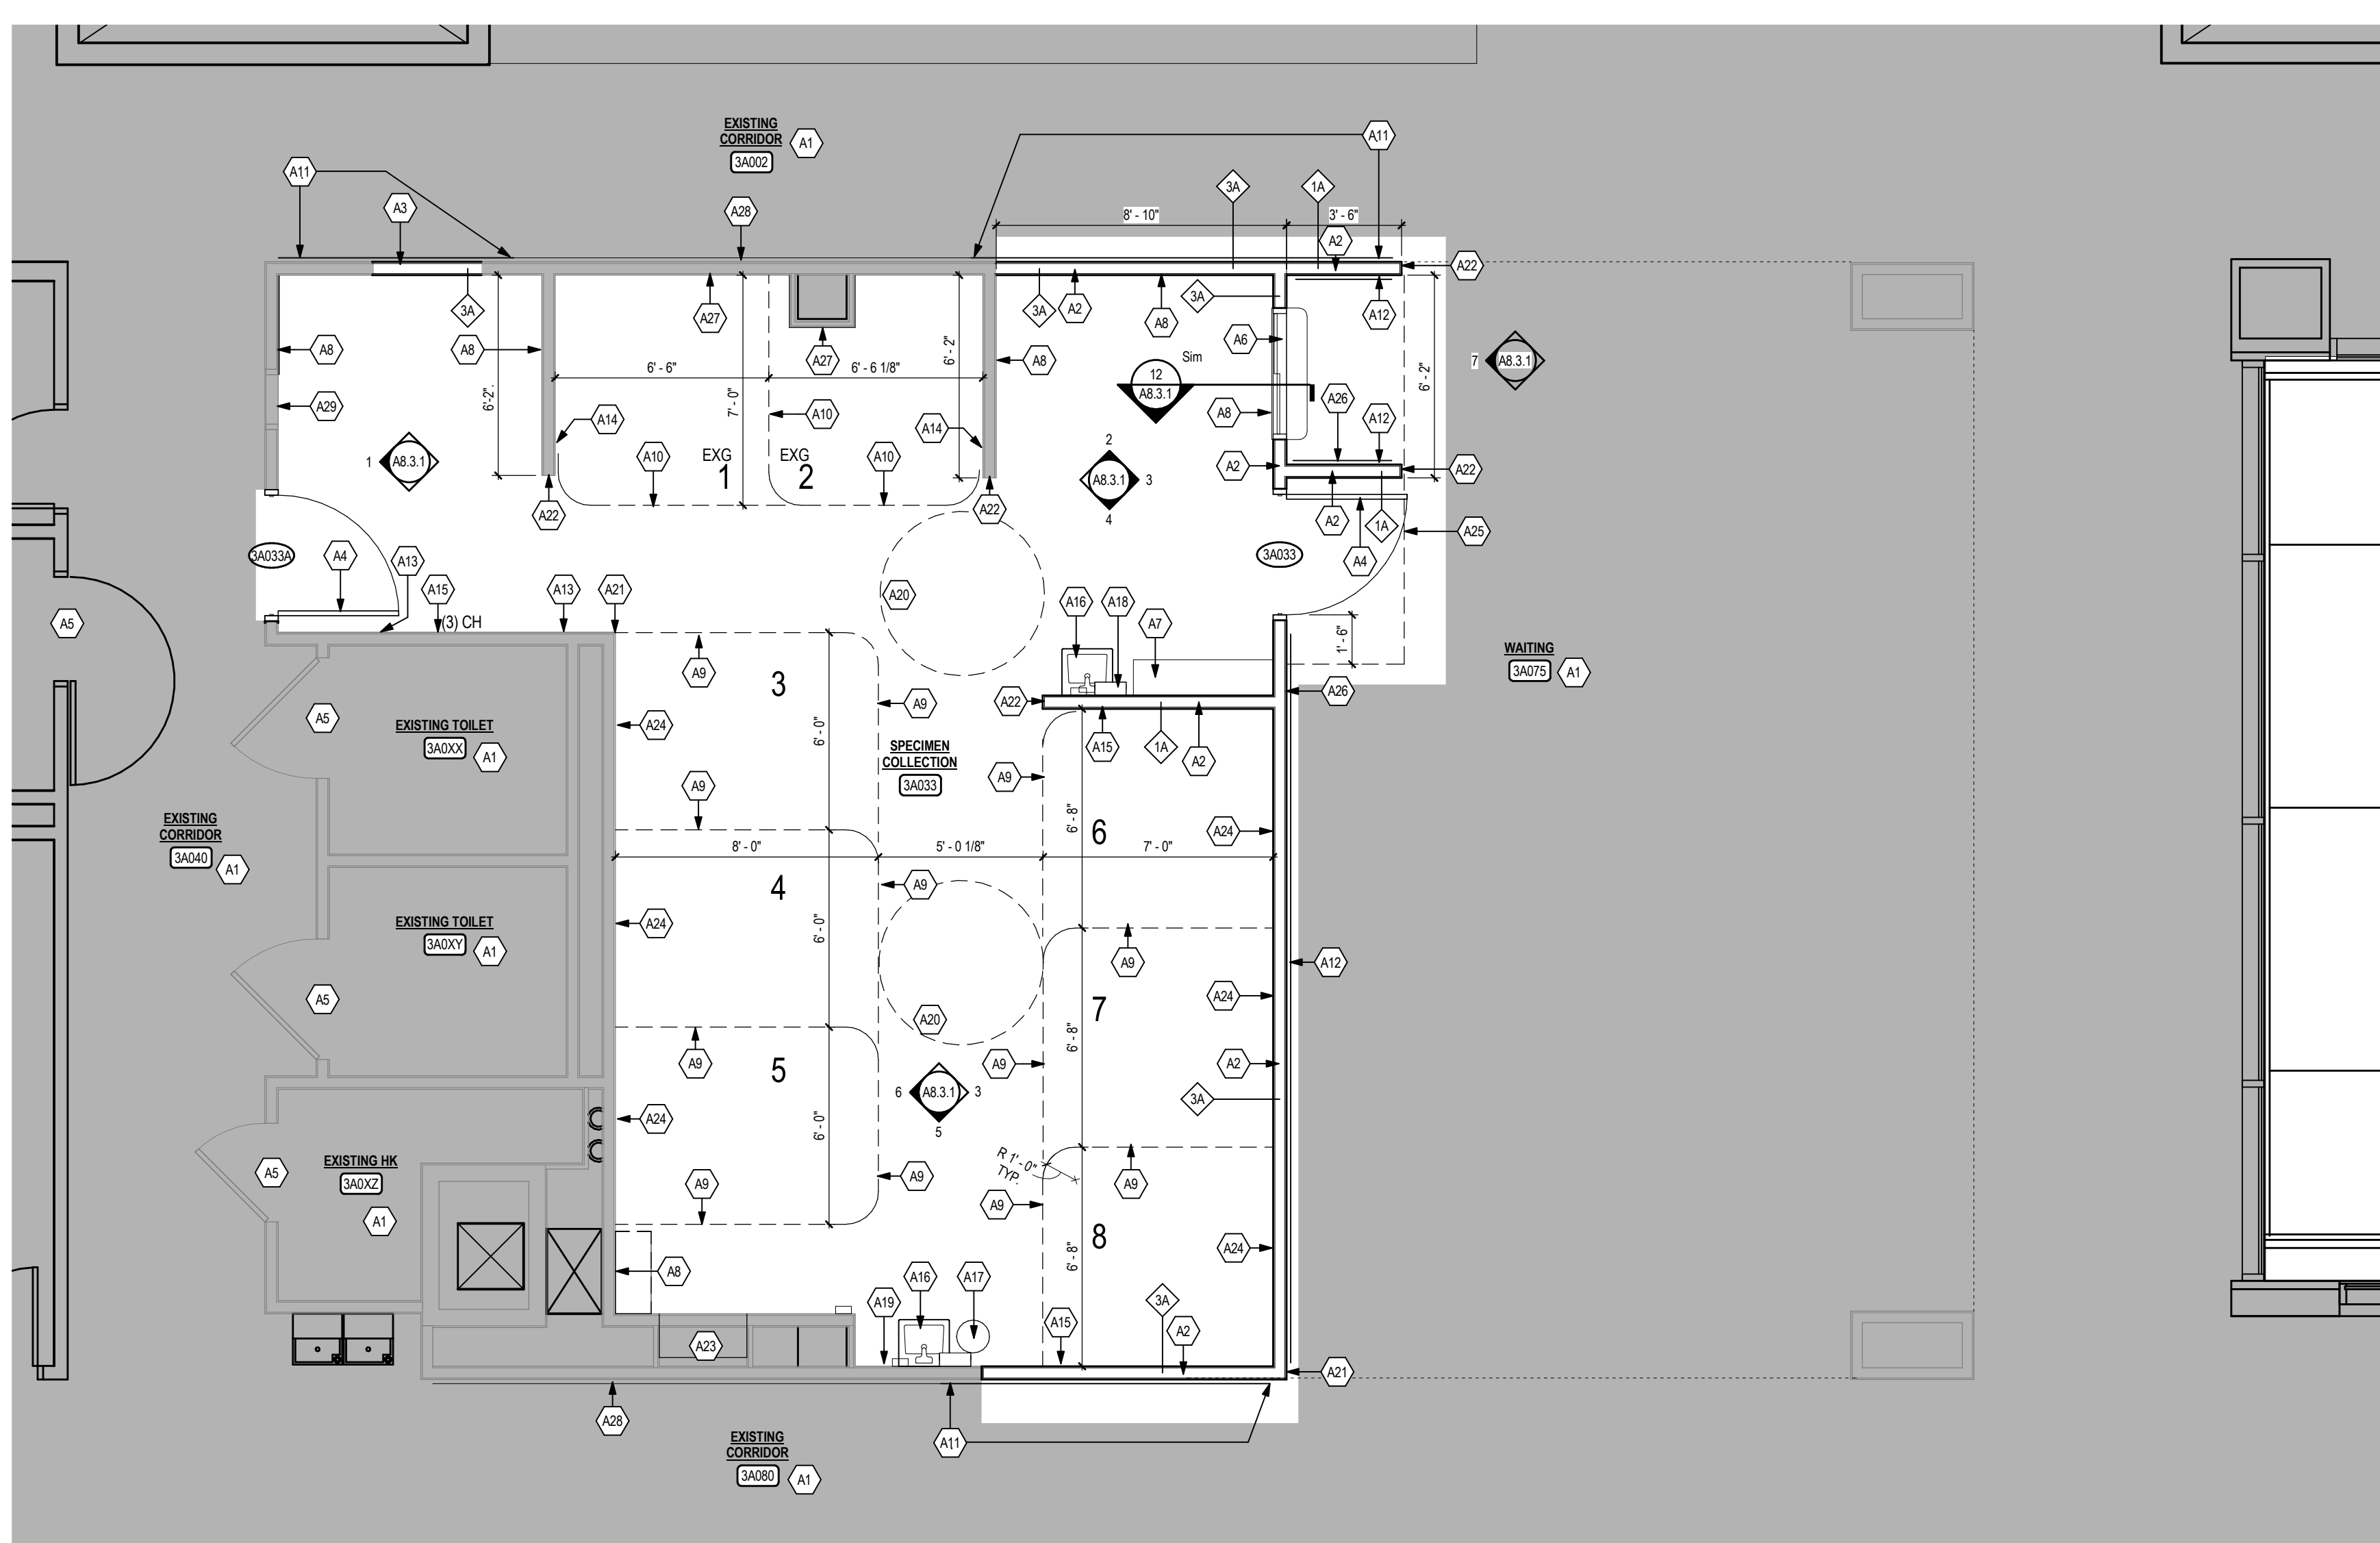
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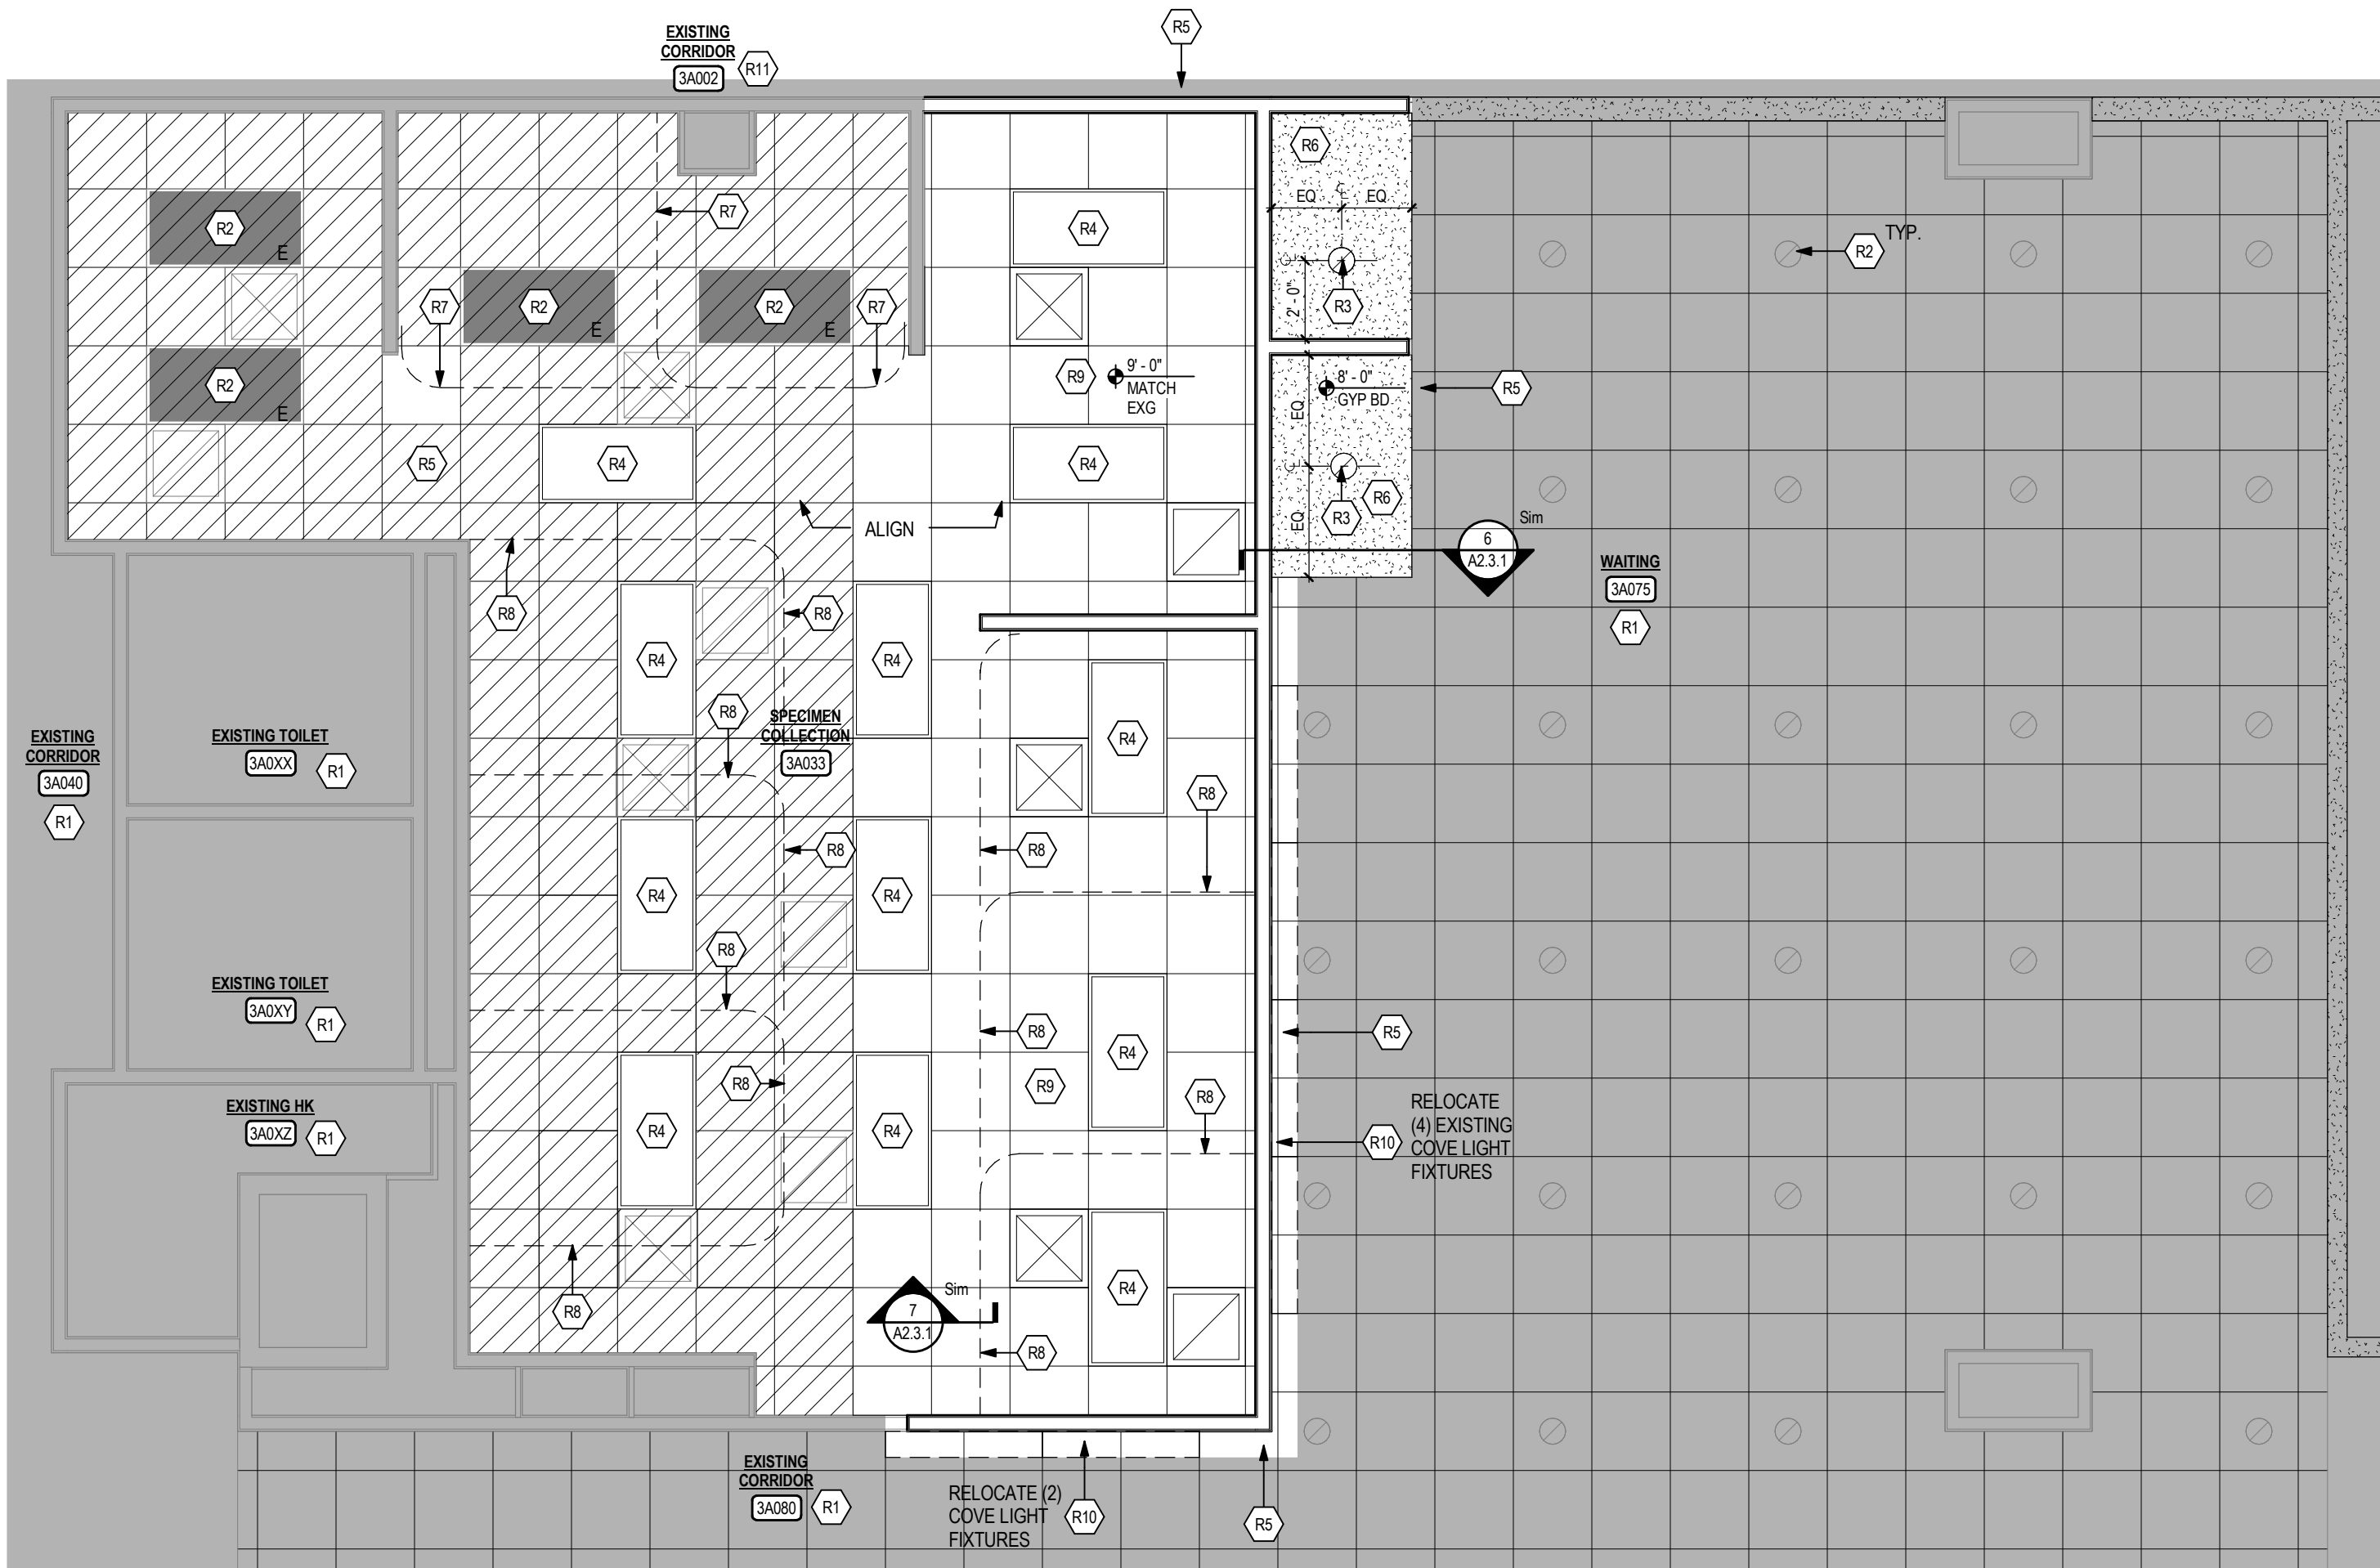
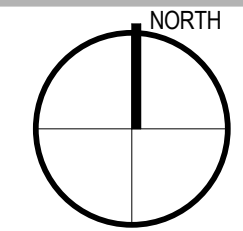
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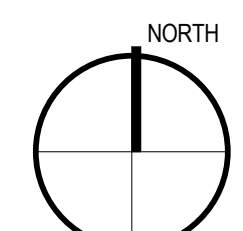
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DEMOLITION PLANS	Expand Specimen Collection Area	757-17-207	
Approved:	Location CHALMERS P. WYLIE VA AMBULATORY CARE CENTER	Building Number 1A	
Date 10 JULY 2015	Checked By: ds	Drawn By: mrh	Drawing Number A1.3.1



1 partial third floor - new work plan
1/4" = 1'-0"

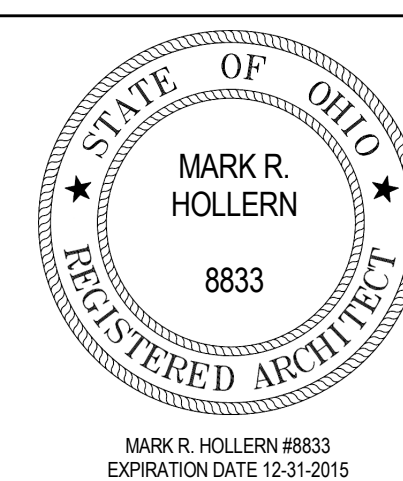

2 partial third floor - reflected ceiling plan
1/4" = 1'-0"



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CONSULTANTS:





Engineering Ltd.
Facility Engineering Consultants
855 Grandview Avenue, 3rd Floor Columbus, OH 43215
Phone: (614) 443-1178 Fax: (614) 443-1594
Email: dynamix@dynamix-td.com
DEL # 13066




ARCHITECT/ENGINEERS:




775 Yard Street, Suite 325
Columbus, Ohio 43212
p 614.764.0407
f 614.764.0237
www.ma-architects.com

Drawing Title <div>PARTIAL THIRD FLOOR – NEW WORK PLANS</div>		Project Title <div>Expand Specimen Collection Area</div>		Project Number <div>757–17–207</div>		<div>Office of Construction and Facilities Management</div> <div> <small>Alumni • Wife Ambulatory Care Center</small></div> <div> <small>Department of Veterans Affairs</small></div>
Approved:		Location <div>CHALMERS P. WYLIE VA AMBULATORY CARE CENTER</div>		Building Number <div>1A</div>		
		Drawing Number <div>A2.3.1</div>				
Date <div>10 JULY 2015</div>		Checked By: <div>ds</div>	Drawn By: <div>mrrh</div>			


DOOR NO	DOOR OPENING SIZE	DOOR TYPE	DOOR MATL FINISH	FRAME TYPE	FRAME MATL FINISH	LABEL (MNS)	DETAIL	HWDR SET	REMARKS
3A033	3'-8" 7'-0"	FL	S.C. WOOD STAINED	A	H.M. PAINTED	---	4	HW-2	REINSTALL EXISTING LOCKSET WITH NEW BALANCE OF HARDWARE
3A033A	3'-8" 7'-0"	FL	S.C. WOOD STAINED	A	H.M. PAINTED	---	4	HW-1	REINSTALL EXISTING LOCKSET WITH NEW BALANCE OF HARDWARE

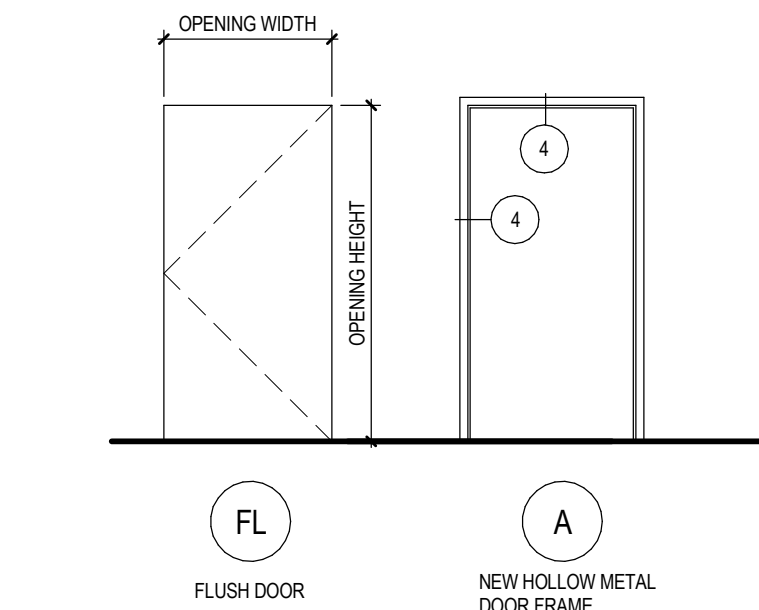


3 door and frame elevations
1/4" = 1'-0"

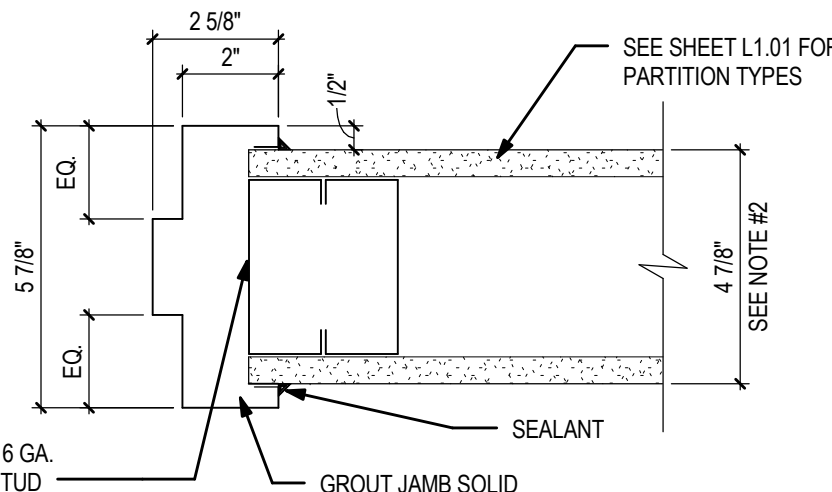


4 detail - h. m. door frame
1/4" = 1'-0"

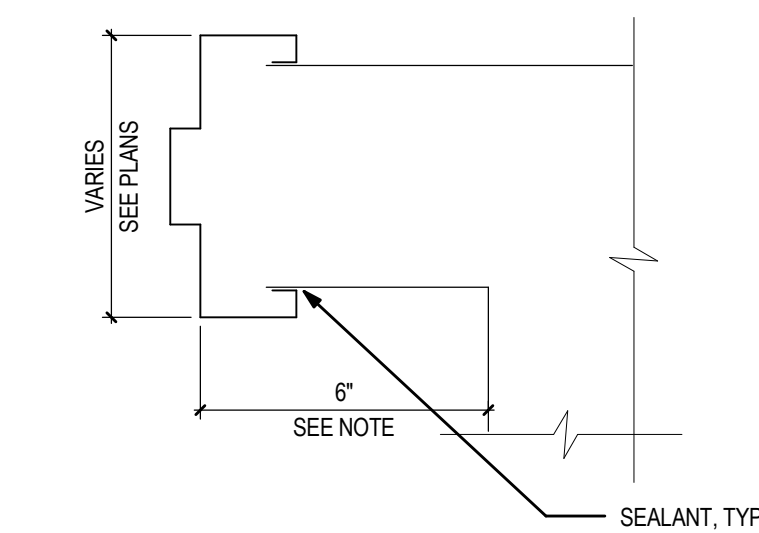


5 detail - typ. door jamb location
3/4" = 1'-0"

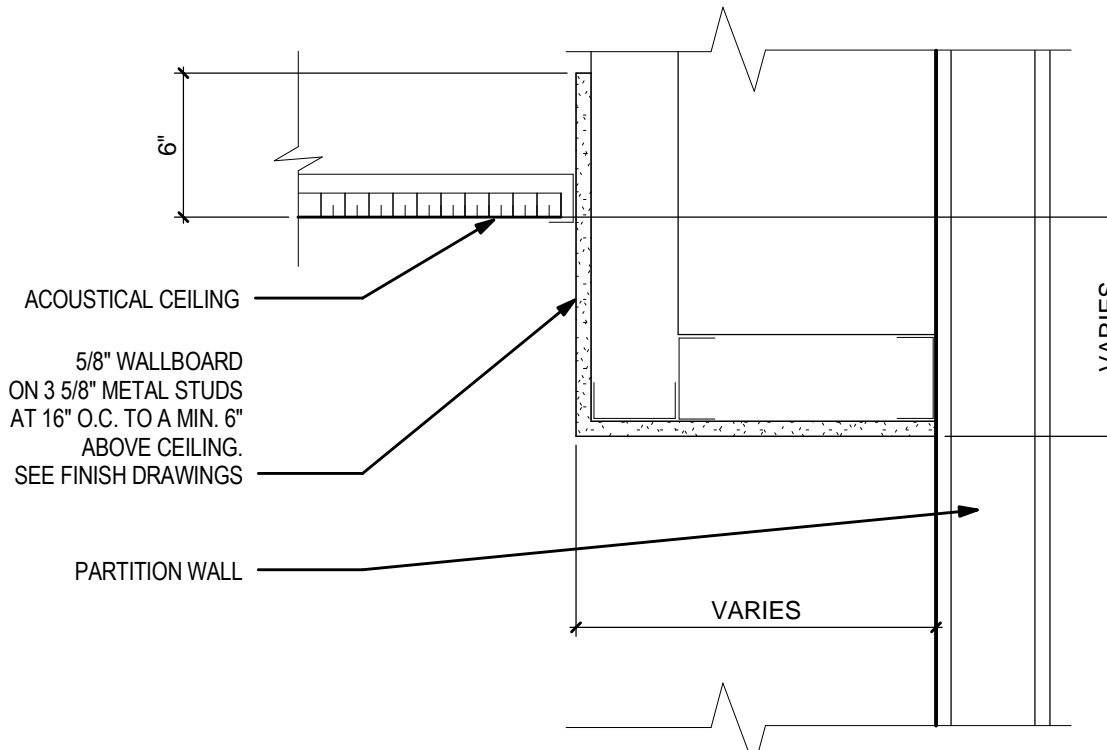


6 detail - wallboard soffit at partition
1 1/2" = 1'-0"

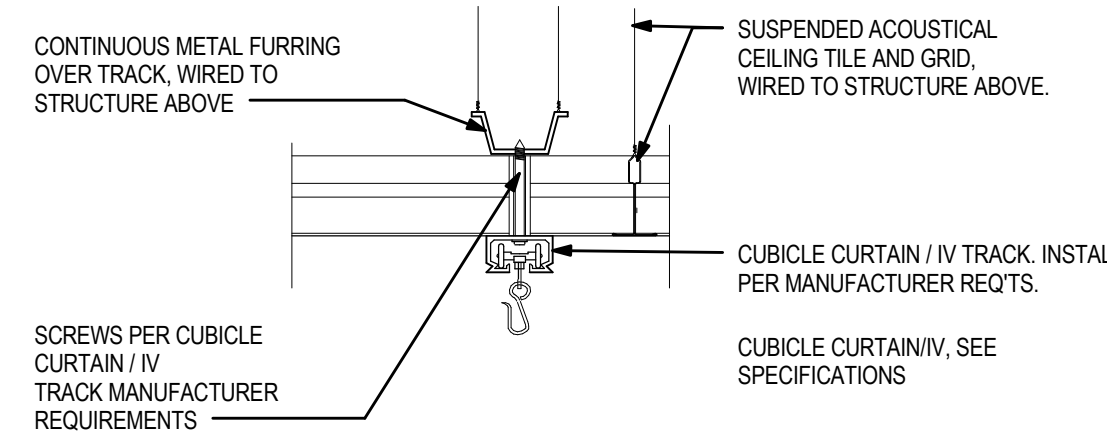

7 detail - cubicle curtain / iv track
3/4" = 1'-0"

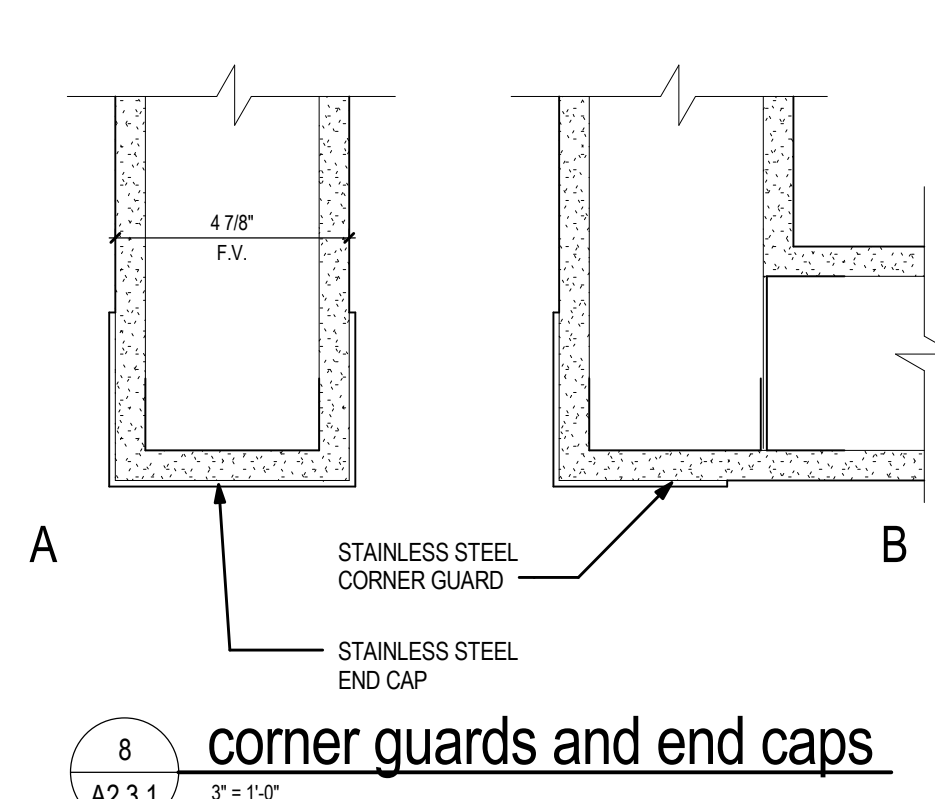

8 corner guards and end caps
3/4" = 1'-0"

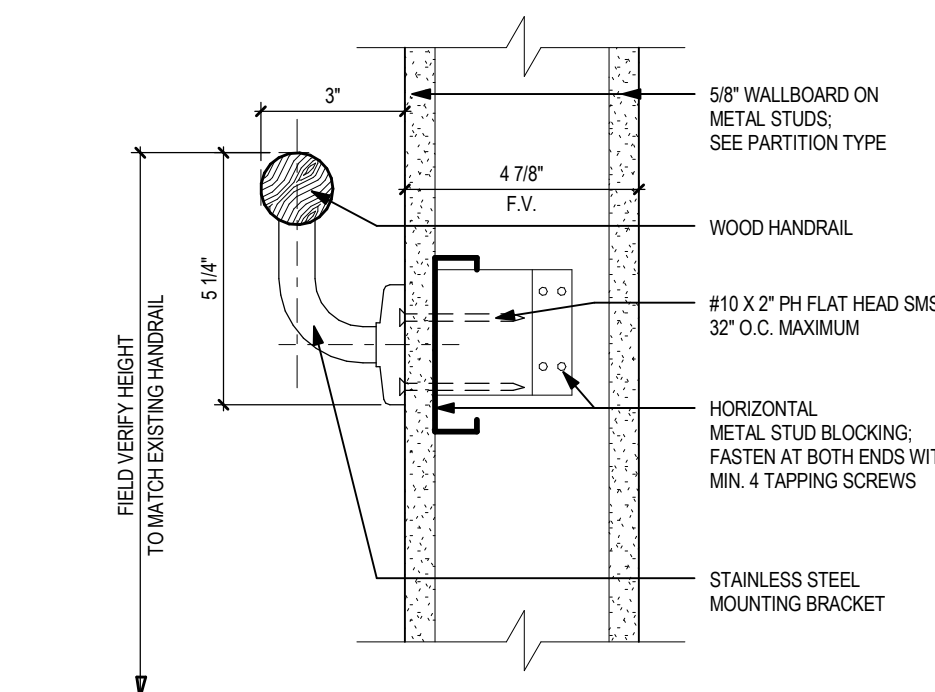


9 hand rails and blocking
3/4" = 1'-0"

REFLECTED CEILING PLAN GENERAL NOTES

- SEE SHEET G10-02 FOR WALL TYPES. ALL WALLS ARE FULL HEIGHT, TYPE 3A, U.N.O.
- SEE SHEET SERIES A9 FOR FINISH INFORMATION.
- SEE THIS SHEET FOR DOOR SCHEDULE AND HARDWARE. SEE SPECIFICATIONS.
- ROOM NUMBERS USED HERE ARE FOR THE PURPOSES OF THIS PROJECT. VERIFY ANY FINAL ROOM NUMBERING SYSTEM WITH THE OWNER PRIOR TO MAKING FINAL MARKS OR SCHEDULES RELATED TO ROOM NUMBERS.
- PATCH AND REPAIR ANY SURFACE OR OTHER ITEM DAMAGED BY OR INVOLVED IN CONSTRUCTION ACTIVITIES TO "AS NEW". REFER TO ENGINEERING DRAWINGS FOR M.E.P. WORK THAT MAY REQUIRE PATCHING BY GENERAL TRIMMER CONTRACTOR.
- PATCH EXISTING FLOOR AND LEVEL IN PREPARATION FOR NEW FINISHED FLOOR.
- SEE DEMOLITION AND PHASING DRAWINGS. A1 SERIES.
- PROVIDE FIRE RATCH AND SUBMIT BURN PERMITS FOR ANY WORK REQUIRING USE OF TOOLS PRODUCING A FLAME.
- BLOCKING NOTED IN WALLS SHOULD BE HORIZONTAL METAL STUDS. SEE DETAIL 9A2.3.1.

REFLECTED CEILING PLAN

GENERALLY, ONLY CEILING MOUNTED FIXTURES ARE SHOWN ON THIS PLAN. REFER TO THE ELECTRICAL LIGHTING PLANS FOR COMPLETE INFORMATION ON THE TYPE AND LOCATION OF ALL EXIT, DISCHARGE, AND EMERGENCY EGRESS FIXTURES.

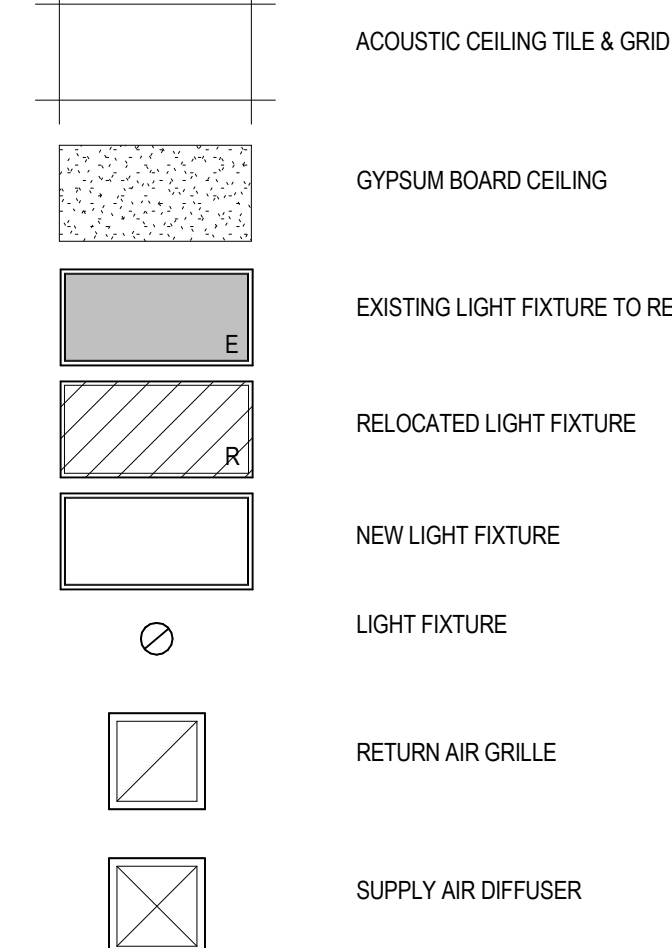

GENERAL FLOOR PLAN NOTES


- SEE SHEET G10-02 FOR WALL TYPES. ALL WALLS ARE FULL HEIGHT, TYPE 3A, U.N.O.
- SEE SHEET SERIES A9 FOR FINISH INFORMATION.
- SEE THIS SHEET FOR DOOR SCHEDULE AND HARDWARE. SEE SPECIFICATIONS.
- ROOM NUMBERS USED HERE ARE FOR THE PURPOSES OF THIS PROJECT. VERIFY ANY FINAL ROOM NUMBERING SYSTEM WITH THE OWNER PRIOR TO MAKING FINAL MARKS OR SCHEDULES RELATED TO ROOM NUMBERS.
- PATCH AND REPAIR ANY SURFACE OR OTHER ITEM DAMAGED BY OR INVOLVED IN CONSTRUCTION ACTIVITIES TO "AS NEW". REFER TO ENGINEERING DRAWINGS FOR M.E.P. WORK THAT MAY REQUIRE PATCHING BY GENERAL TRIMMER CONTRACTOR.
- PATCH EXISTING FLOOR AND LEVEL IN PREPARATION FOR NEW FINISHED FLOOR.
- SEE DEMOLITION AND PHASING DRAWINGS. A1 SERIES.
- PROVIDE FIRE RATCH AND SUBMIT BURN PERMITS FOR ANY WORK REQUIRING USE OF TOOLS PRODUCING A FLAME.
- BLOCKING NOTED IN WALLS SHOULD BE HORIZONTAL METAL STUDS. SEE DETAIL 9A2.3.1.

FLOOR PLAN CODED NOTES


- EXISTING TO REMAIN.
- NEW PARTITION WALL. SEE PARTITION SCHEDULE ON SHEET G10-02.
- INFILL EXISTING PARTITION TO MATCH EXISTING. SEE PARTITION SCHEDULE ON SHEET G10-02.
- NEW WOOD DOOR IN HOLLOW METAL FRAME. PAINT FRAME. SEE DOOR SCHEDULE THIS SHEET.
- EXISTING DOOR TO REMAIN.
- NEW PASS WINDOW W/ LOCK AND PLAM TRANSACTION TOP. SEE DETAIL 12A8.3.1.
- AT MILLWORK. SEE ELEVATIONS AND DETAILS, SHEET A8.3.1.
- PROVIDE BLOCKING IN WALLS FOR OWNER FURNISHED AND OWNER INSTALLED SYSTEMS FURNITURE. SEE LOCATIONS ON SHEET A8.3.1. REPAIR EXISTING PARTITION WALLS TO LEVEL 4 FINISH.
- EXISTING CURTAIN TRACKS, CFCI, CURTAINS, OFOL.
- EXISTING CURTAIN CURTAIN TRACK TO REMAIN.
- EXTEND EXISTING WOOD / METAL HANDRAIL ALONG WALL EXTENSION. REUSE SALVAGED END CAPS AND WOOD RAIL SUPPLEMENTING WITH NEW AS NEEDED. INSTALL BLOCKING IN EXISTING AND NEW WALL PARTITIONS AND REPAIR EXISTING PARTITION WALLBOARD TO LEVEL FOUR FINISH. SEE DETAIL 9A2.3.1.
- WOOD / METAL HANDRAIL TO MATCH EXISTING. PROVIDE BLOCKING IN PARTITIONS. SEE DETAIL 9A2.3.1.
- EXISTING COAT HOOKS TO REMAIN.
- REINSTALL EXISTING COAT HOOK AT NEW LOCATION.
- NEW COAT HOOK.
- MOUNTED SINK. SEE PLUMBING DRAWINGS.
- EYE WASH. SEE PLUMBING DRAWINGS.
- REINSTALL EXISTING SOAP, ALCOHOL AND PAPER TOWEL DISPENSER AT SINK. SEE ELEVATIONS SHEET A8.3.1.
- SOAP, ALCOHOL AND PAPER TOWEL DISPENSER, OFCI.
- ADA TURNING RADIUS.
- 90 DEGREE STAINLESS STEEL CORNER GUARD TO MATCH EXISTING. HEIGHT TO 7'-2" A.F.F. SEE DETAIL 8B/A2.3.1.
- STAINLESS STEEL END CAP GUARD TO MATCH EXISTING. HEIGHT TO 7'-2" A.F.F. SEE PARTITION SCHEDULE ON G10-02 FOR WIDTH. SEE DETAIL 8A/A2.3.1.
- EXISTING PNEUMATIC TUBE STATION TO REMAIN.
- PROVIDE BLOCKING IN WALLS FOR OFCI COMPUTER WALL BRACKETS. SEE ELEVATIONS SHEET A8.3.1 FOR TYPICAL LAYOUT. REPAIR EXISTING WALLBOARD ON EXISTING PARTITIONS TO LEVEL 4 FINISH.
- LINE OF SOFFIT ABOVE. SEE REFLECTED CEILING DRAWINGS.
- SIGNAGE OFCI.
- EXISTING COMPUTER WALL BRACKET TO REMAIN.
- EXISTING WOOD HANDRAIL TO REMAIN.
- EXISTING PASS THROUGH WINDOW TO REMAIN.

REFLECTED CEILING CODED NOTES


- EXISTING TO REMAIN.
- EXISTING LIGHT FIXTURE TO REMAIN.
- RELOCATED LIGHT FIXTURE. SEE ELECTRICAL DRAWINGS.
- NEW LIGHT FIXTURE. SEE ELECTRICAL DRAWINGS.
- EXISTING ACOUSTICAL CEILING AND GRID TO REMAIN. MODIFY AT MODIFIED PARTITION WALLS, LIGHT FIXTURES AND OTHER FIXTURES. SEE HVAC AND LIGHTING DRAWINGS.
- WALLBOARD SOFFIT. PAINT ACCENT COLOR ALL SIDES AND BOTTOM.
- EXISTING CURTAIN CURTAIN TRACK TO REMAIN. ADJUST TRACK AS NEEDED AT MODIFIED PARTITION WALLS AND AT MODIFIED CEILING TILES.
- CURTAIN CURTAIN TRACK, CFCI, CURTAIN, OFOL. SEE FLOOR PLANS FOR DIMENSIONS.
- NEW ACOUSTICAL CEILING AND GRID TO MATCH EXISTING AT EXISTING CEILING ELEVATION. SEE HVAC DRAWINGS FOR NEW DIFFUSERS AND RETURN AIR DEVICES. SEE ELECTRICAL DRAWINGS.
- REINSTALL EXISTING SALVAGED WALL MOUNTED LIGHT FIXTURES. SEE ELECTRICAL DRAWINGS.
- REMOVE AND REPLACE EXISTING ACT IN CORRIDOR AND ROOMS FROM THIS POINT TO THE ELECTRICAL AND DATA ROOMS NOTED IN ELECTRICAL DRAWINGS. TO INSTALL NEW WIRING TO PANELS.

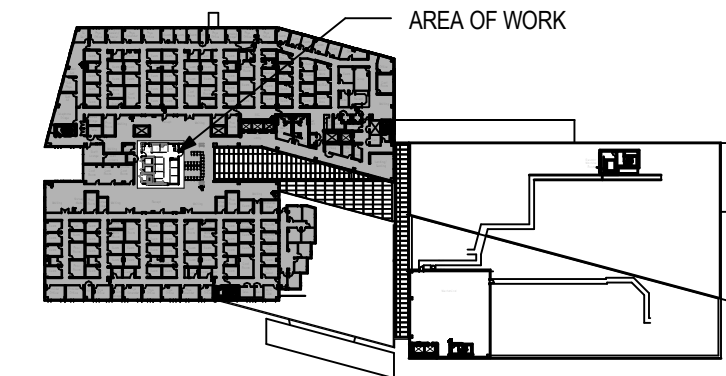


third floor - key plan
1" = 160'-0"

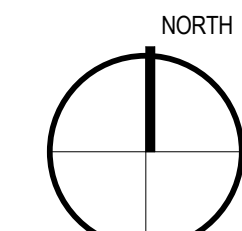

one eighth inch = one foot
one quarter inch = one foot
three eighths inch = one foot
one half inch = one foot
three quarters inch = one foot
one inch = one foot
one and one half inches = one foot
three inches = one foot

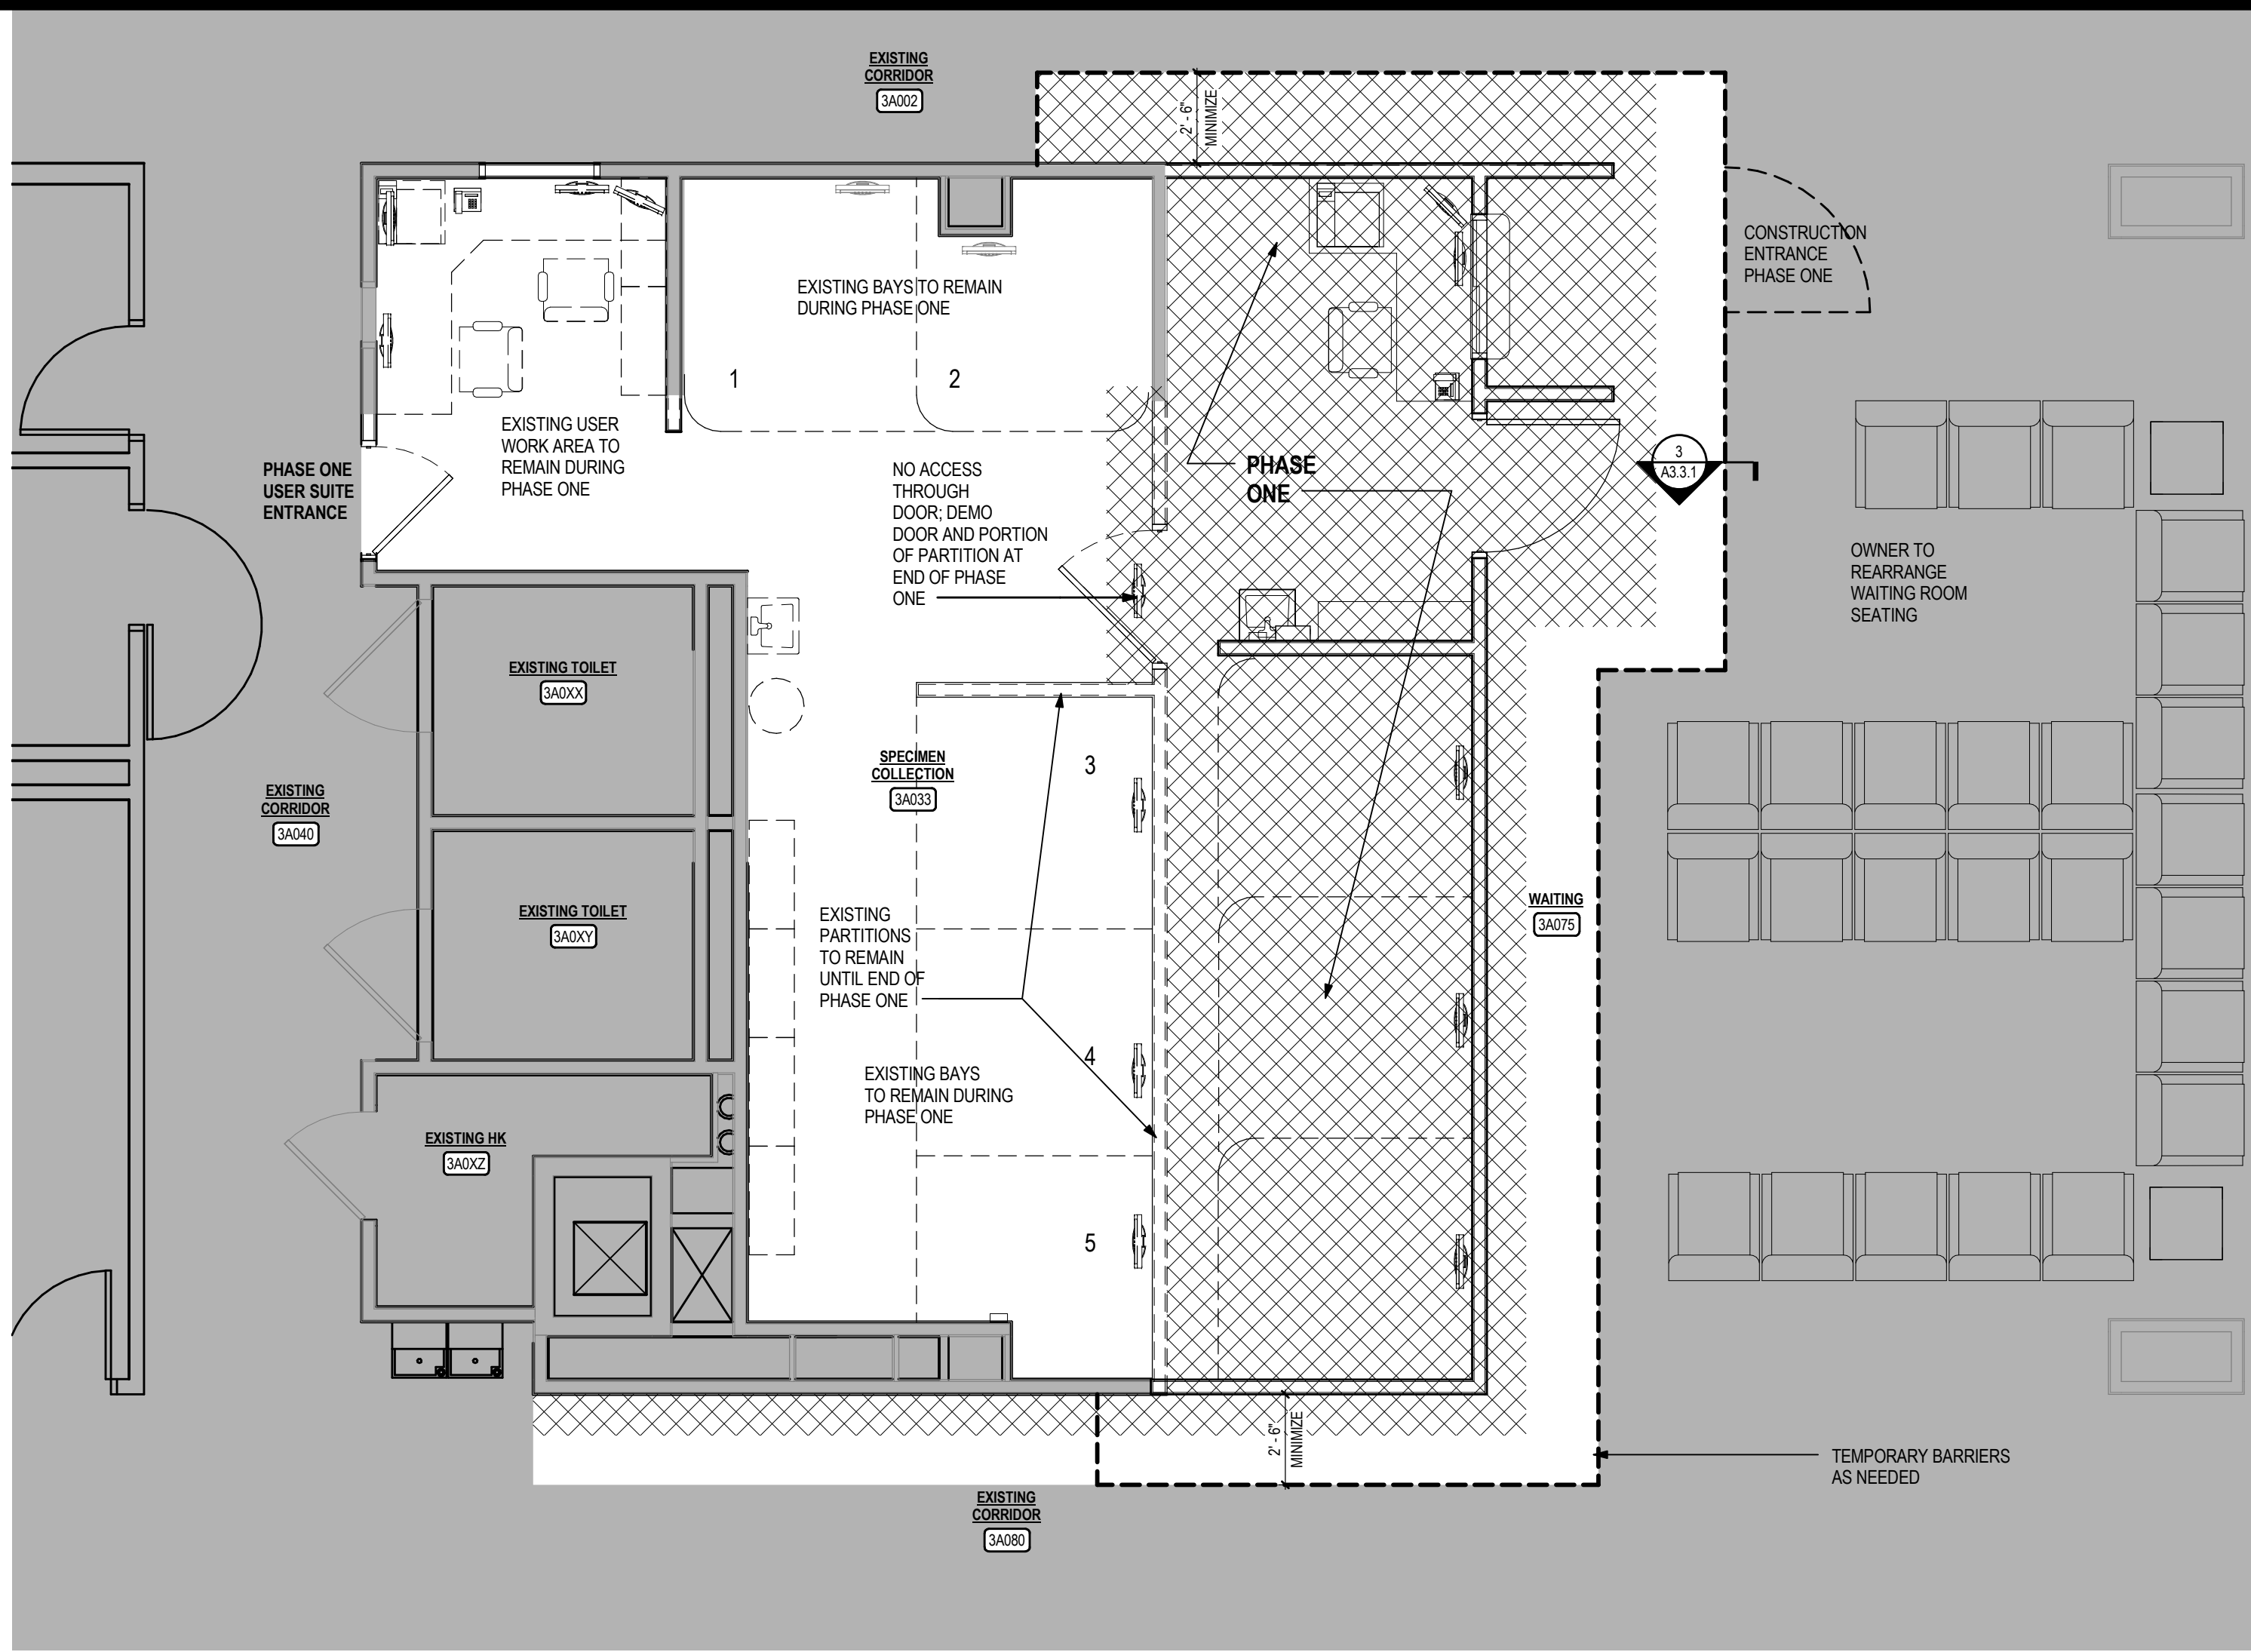


1 partial third floor - phase 1 plan
1/4" = 1'-0"

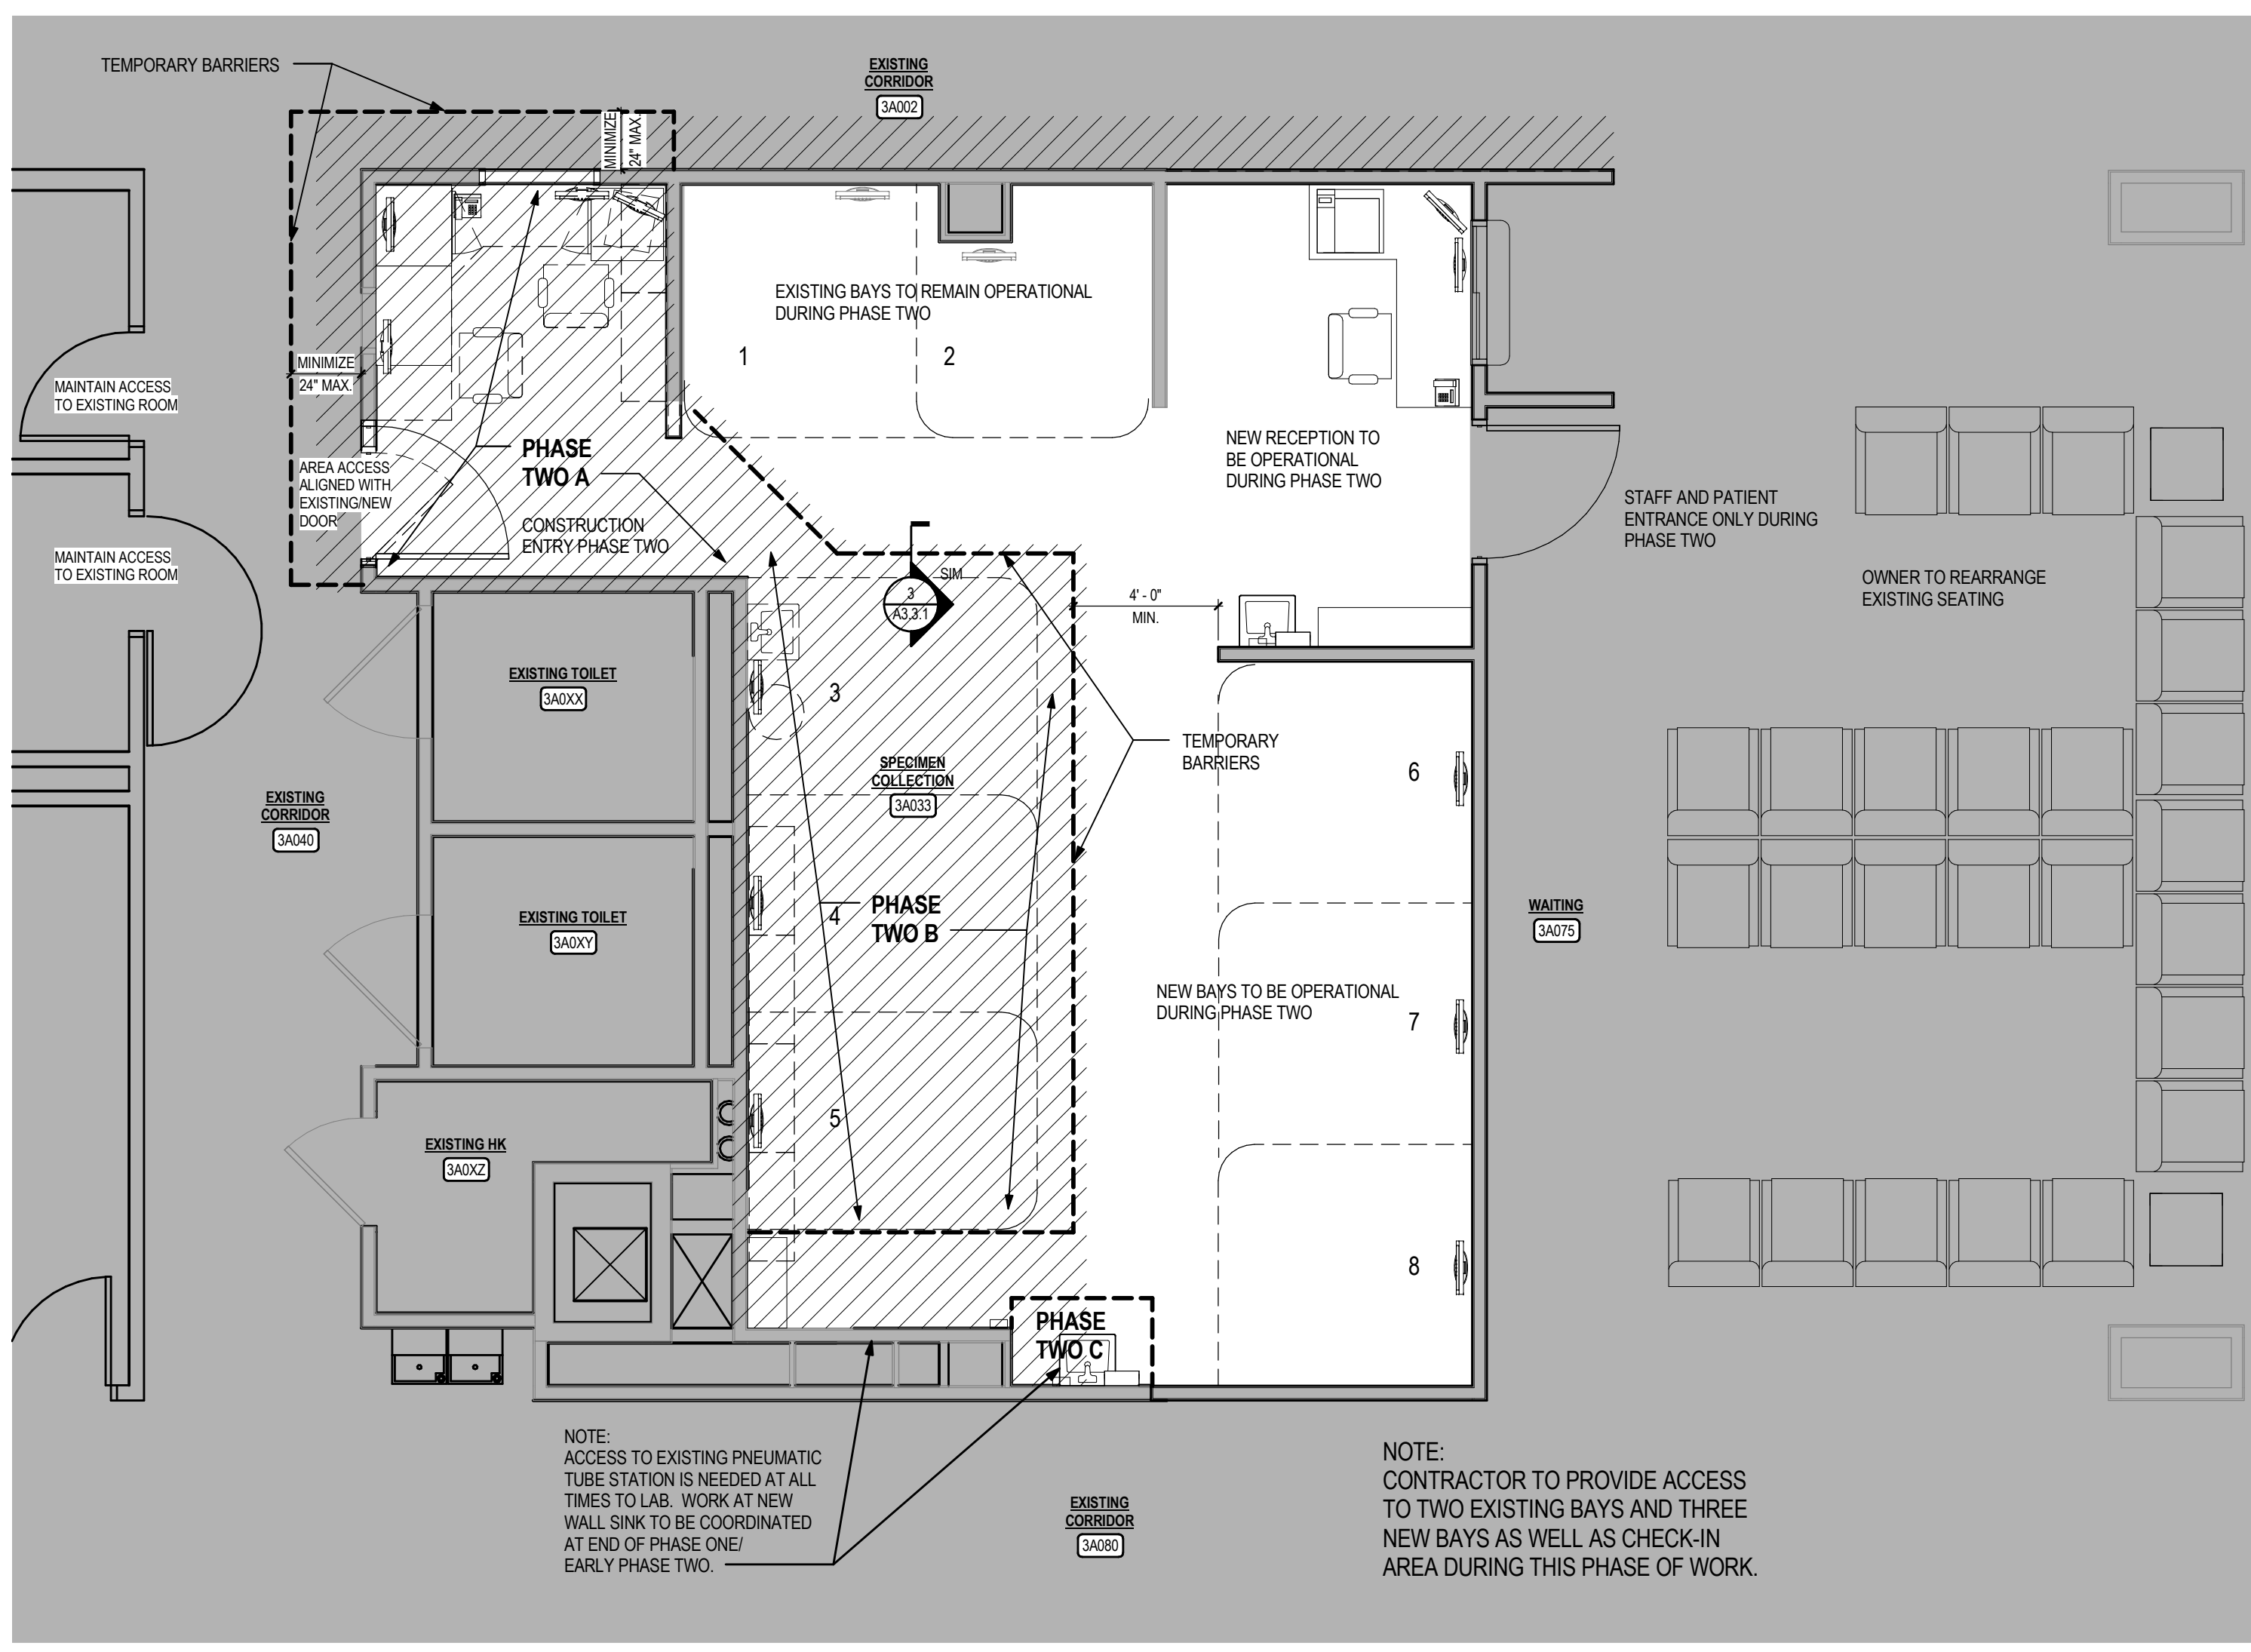

2 partial third floor - phase 2 plan
1/4" = 1'-0"

PHASING PLAN GENERAL NOTES

- A. WORK SHALL BE PHASED ALLOWING THE EXISTING SPECIMEN COLLECTION TENANTS TO REMAIN DURING CONSTRUCTION.
- B. PHASE ONE: EXPANSION AREA
1. CONSTRUCT THE AREA OF EXPANSION OUT INTO THE WAITING AREA, LEAVING EXISTING PARTITIONS BETWEEN NEW AND EXISTING IN PLACE UNTIL THE END OF PHASE ONE. REMAINING AREA SHALL BE OCCUPIED BY THE EXISTING TENANTS USING THE EXISTING WEST DOOR ENTRANCE.
2. REMOVE EXISTING PARTITIONS BETWEEN NEW AND EXISTING WORK AT END OF PHASED WORK IN PREPARATION FOR NEW FLOORING AND NEXT PHASE OF WORK. COORDINATE SCHEDULE WITH COR.
3. INSTALL NEW FLOORING IN ENTIRE SUITE AT END OF PHASE ONE. PROTECT FROM FURTHER RENOVATION WORK. COORDINATE SCHEDULE WITH COR.
- C. PHASE TWO: RENOVATE THE EXISTING SUITE AREAS.
AREA A. RENOVATE THE EXISTING SPECIMEN DROP AREA, REPLACING EXISTING DOOR AND INFILLING WINDOW AT SAME TIME AS AREA 2B. TURN OVER AREA 2A AS SOON AS POSSIBLE TO OWNER AND REDUCE THE SIZE OF THE CONSTRUCTION ZONE. (TENANTS WILL NOW BE USING THE NEWLY RENOVATED ADJACENT AREA PHASE ONE DURING THIS CONSTRUCTION).
AREA B. RENOVATE THE EXISTING BAY AREAS 3, 4, AND 5 AT SAME TIME AS AREA 2A.
AREA C. STAFF MUST MAINTAIN ACCESS TO THE EXISTING PNEUMATIC TUBE STATION (PTS) DURING PHASE TWO CONSTRUCTION FROM NEWLY PHASE ONE RENOVATED AREA.
THE NEW SINK ON SOUTH WALL CAN BE PHASED AT BEGINNING OR END OF THE SECOND PHASE TO NOT OBSTRUCT THE ACCESS TO THE PTS.
- D. CONSTRUCT TEMPORARY PARTITIONS AS REQUIRED TO MANAGE PHASES ONE AND TWO, PROVIDING DUST AND NOISE CONTROL TO ADJACENT SPACES OF THE AMBULATORY CARE CENTER.
- E. MAINTAIN ACCESS INTO THE SPECIMEN COLLECTION SUITE AREAS AT ALL TIMES THROUGH ONE OF THE TWO SETS OF DOORS FOR USE BY STAFF AND PATIENTS. MAINTAIN A MINIMUM OF 5 WORKING BLOOD DRAW STATIONS AT ANY TIME DURING THE CONSTRUCTION.
- F. SEE DEMOLITION AND NEW WORK PLANS.

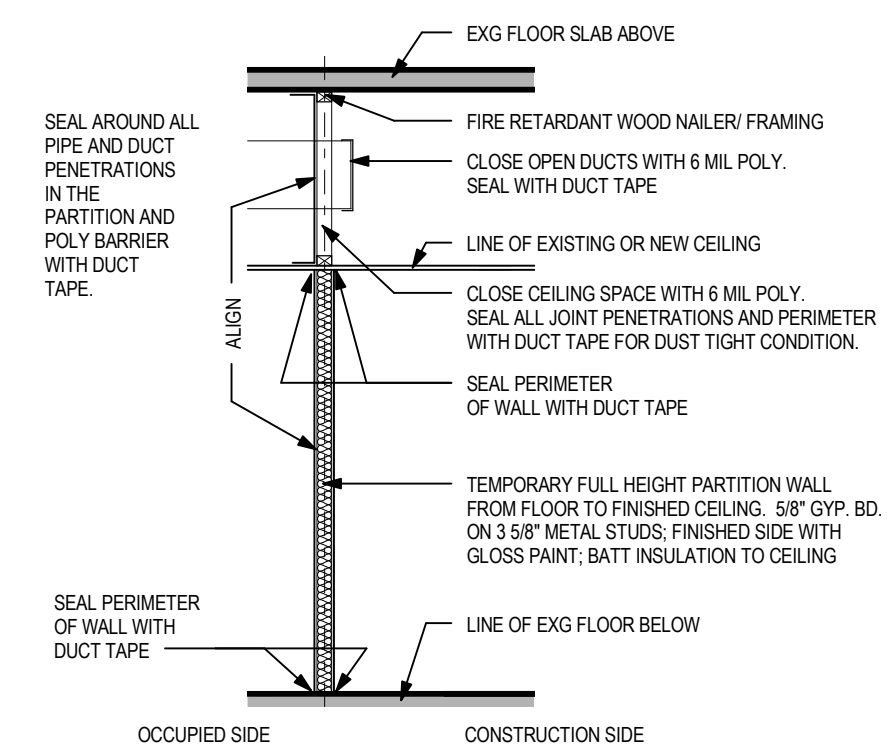


3 section - ICRA partition
1/4" = 1'-0"

CONTRACT DOCUMENTS - BID SET	7/10/15
CONTRACT DOCUMENTS - 100%	6/10/15
CONTRACT DOCUMENTS - 90% REVIEW SET	5/15/15
DESIGN DEVELOPMENT - 60% REVIEW SET	4/10/15
Revisions:	Date



CONSULTANTS:

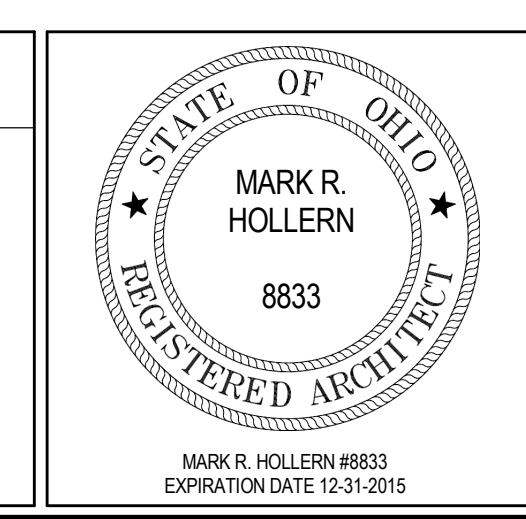DynamiX Engineering Ltd.
Facility Engineering Consultants
855 Grandview Avenue, 3rd Floor Columbus, OH 43215
Phone: (614) 443-1178 Fax: (614) 443-1594
Email: dynamix@dynamix-td.com
DEL # 13066



ARCHITECT/ENGINEERS:

ma
775 Yard Street, Suite 325
Columbus, Ohio 43212
p 614.764.0407
f 614.764.0237
www.ma-architects.com

CONSTRUCTION DOCUMENTS – BID SET					
Drawing Title PHASING PLANS		Project Title Expand Specimen Collection Area		Project Number 757-17-207	Office of Construction and Facilities Management
				Building Number 1A	
Approved:		Location CHALMERS P. WYLIE VA AMBULATORY CARE CENTER		Drawing Number	
				A3.3.1	
		Date 10 JULY 2015	Checked By: Checker		Drawn By: Author
<div></div>					

A

B


C

D


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F


G

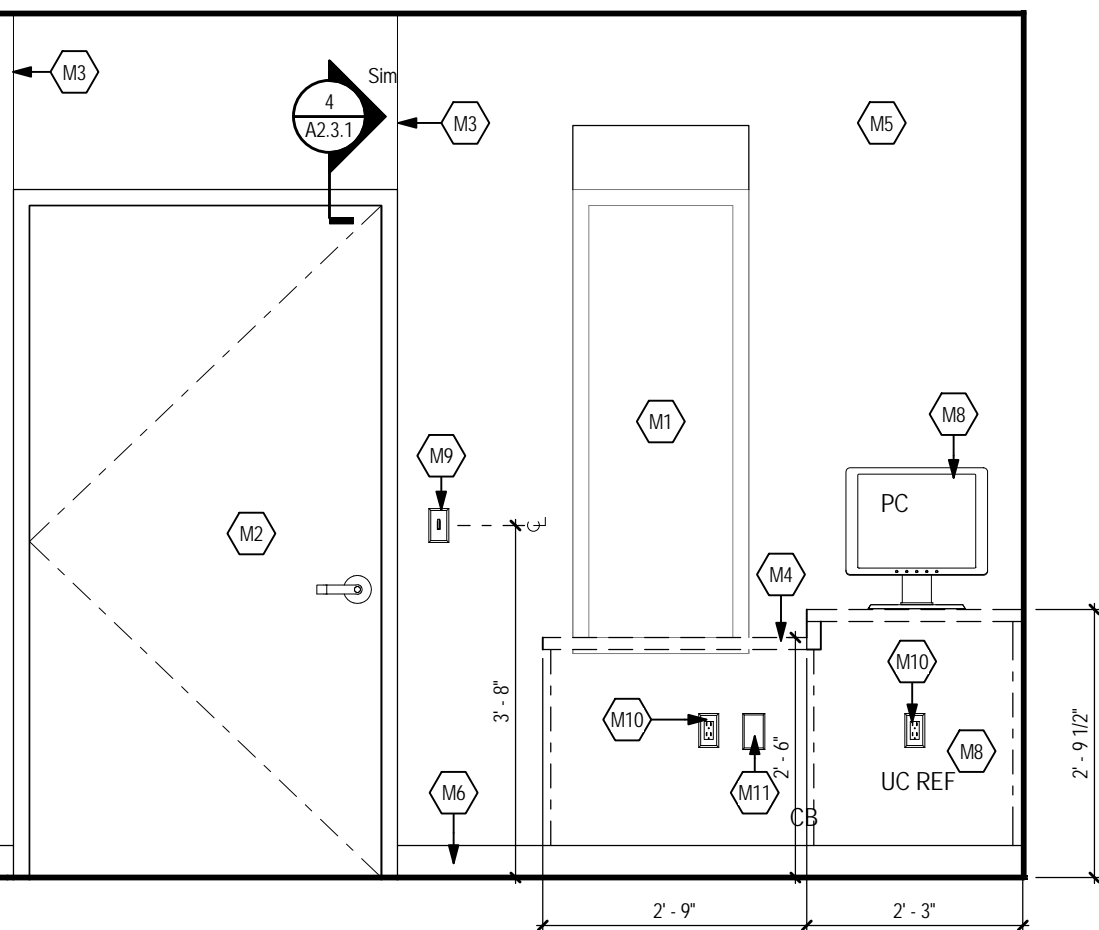

1 elevation - samples
A8.3.1 1/2" = 1'-0"

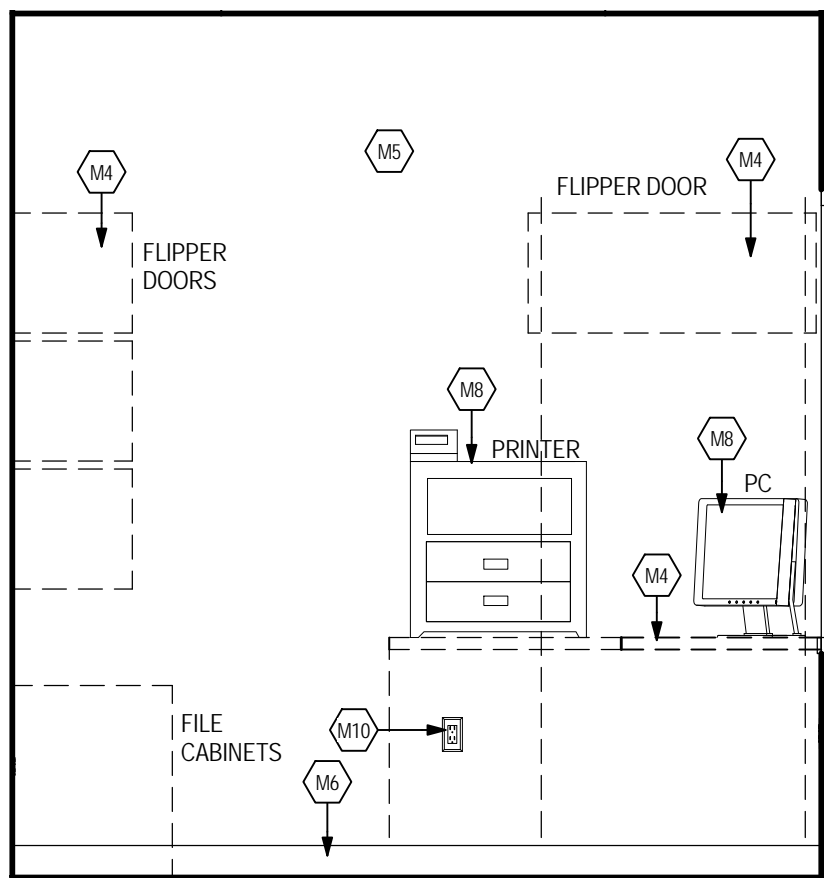


2 elevation - reception north
A8.3.1 1/2" = 1'-0"

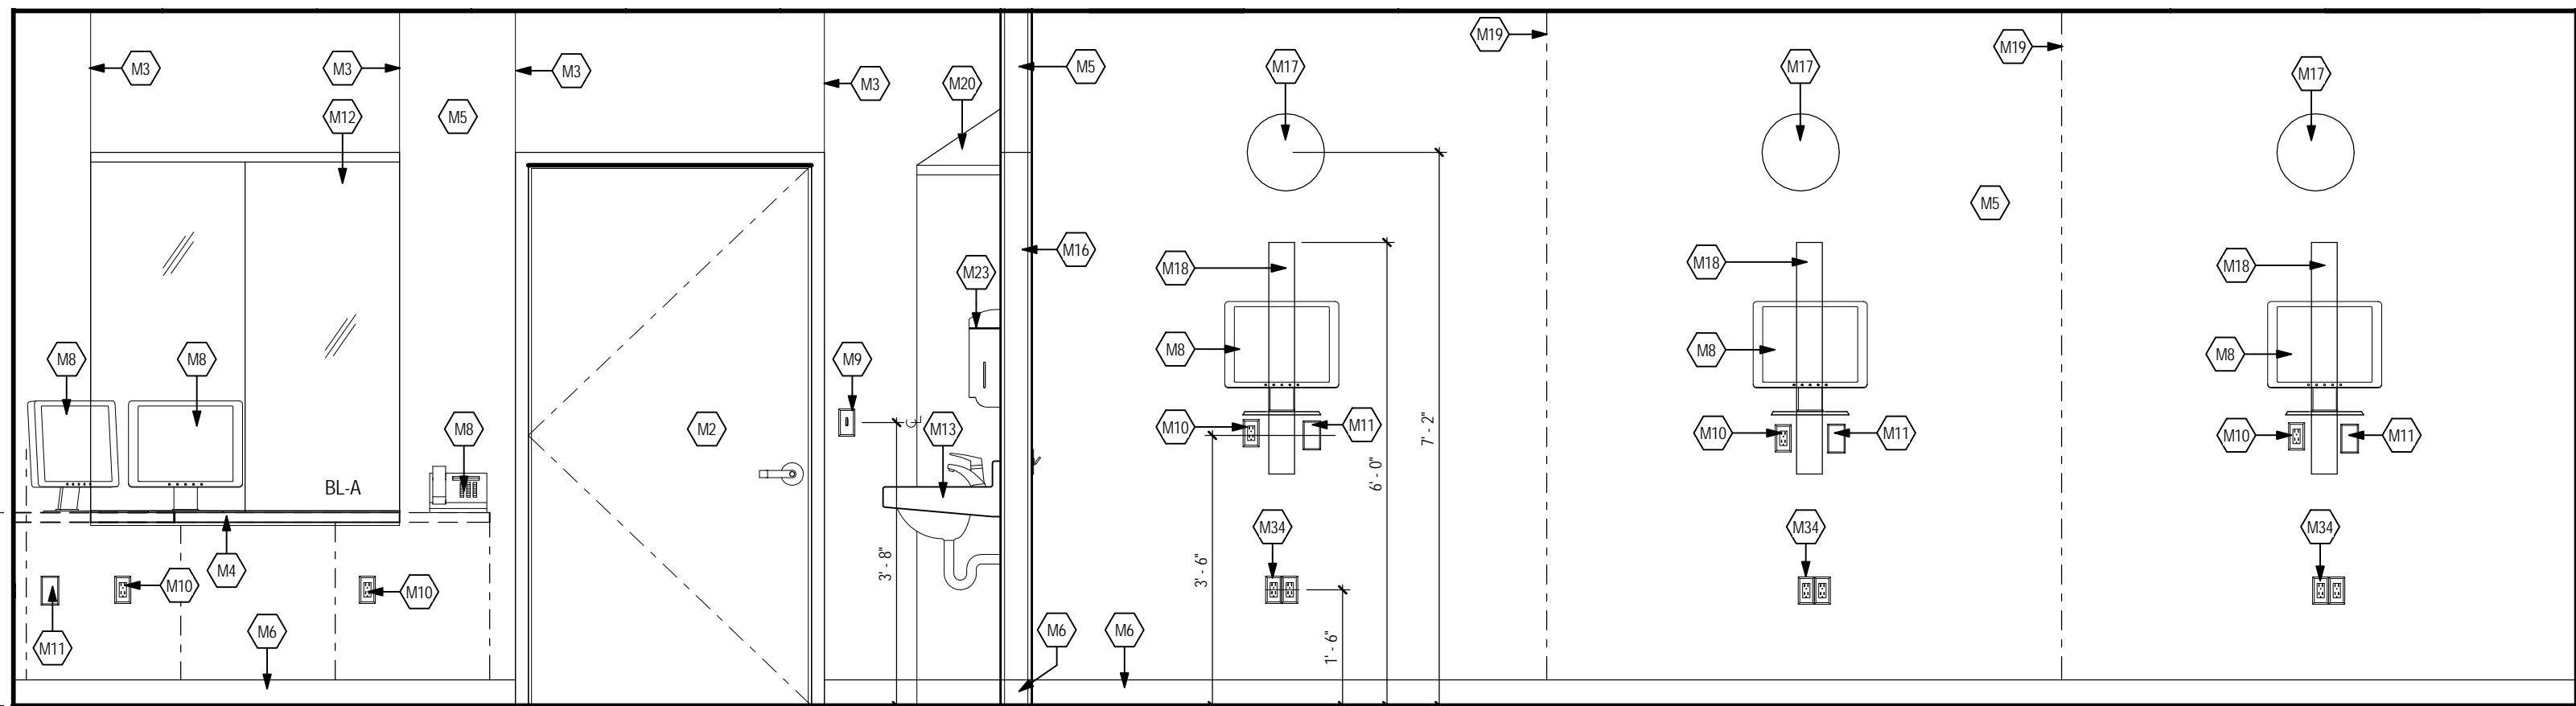


3 elevation - reception east
A8.3.1 1/2" = 1'-0"


NOTE: DIMENSIONS SHOWN IN THIS BAY ARE TYPICAL FOR ALL THE SIX NEW BAY'S COMPONENTS

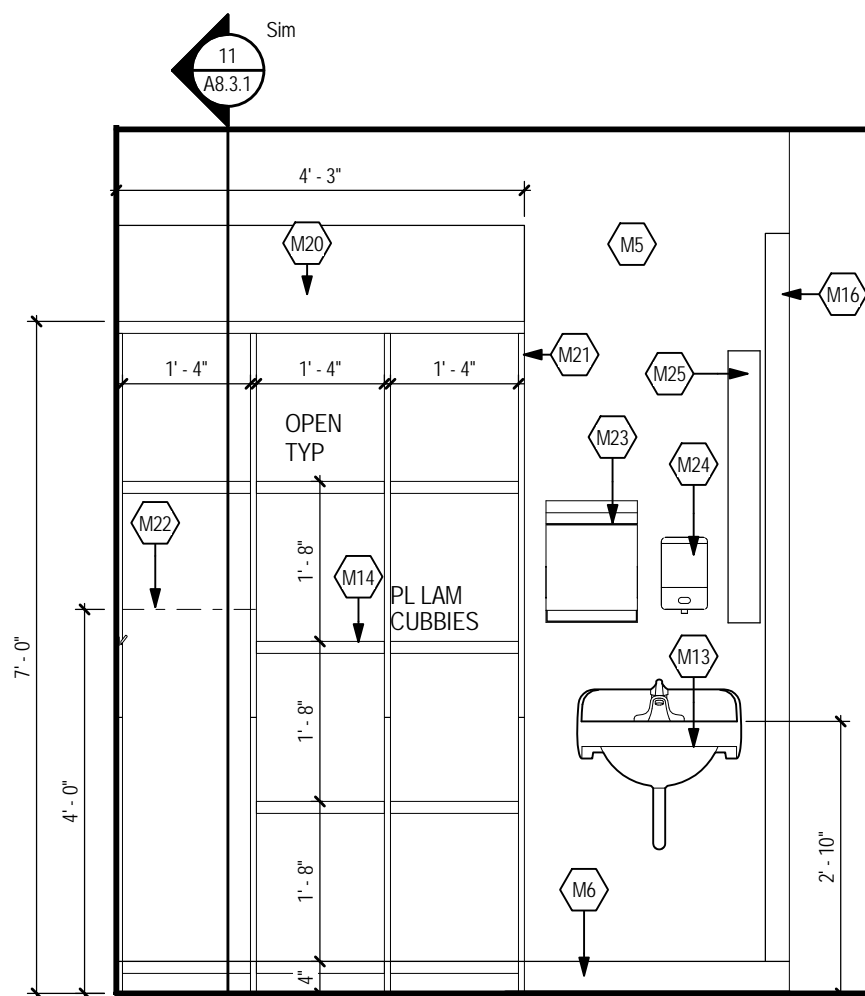


4 elevation - reception south
A8.3.1 1/2" = 1'-0"

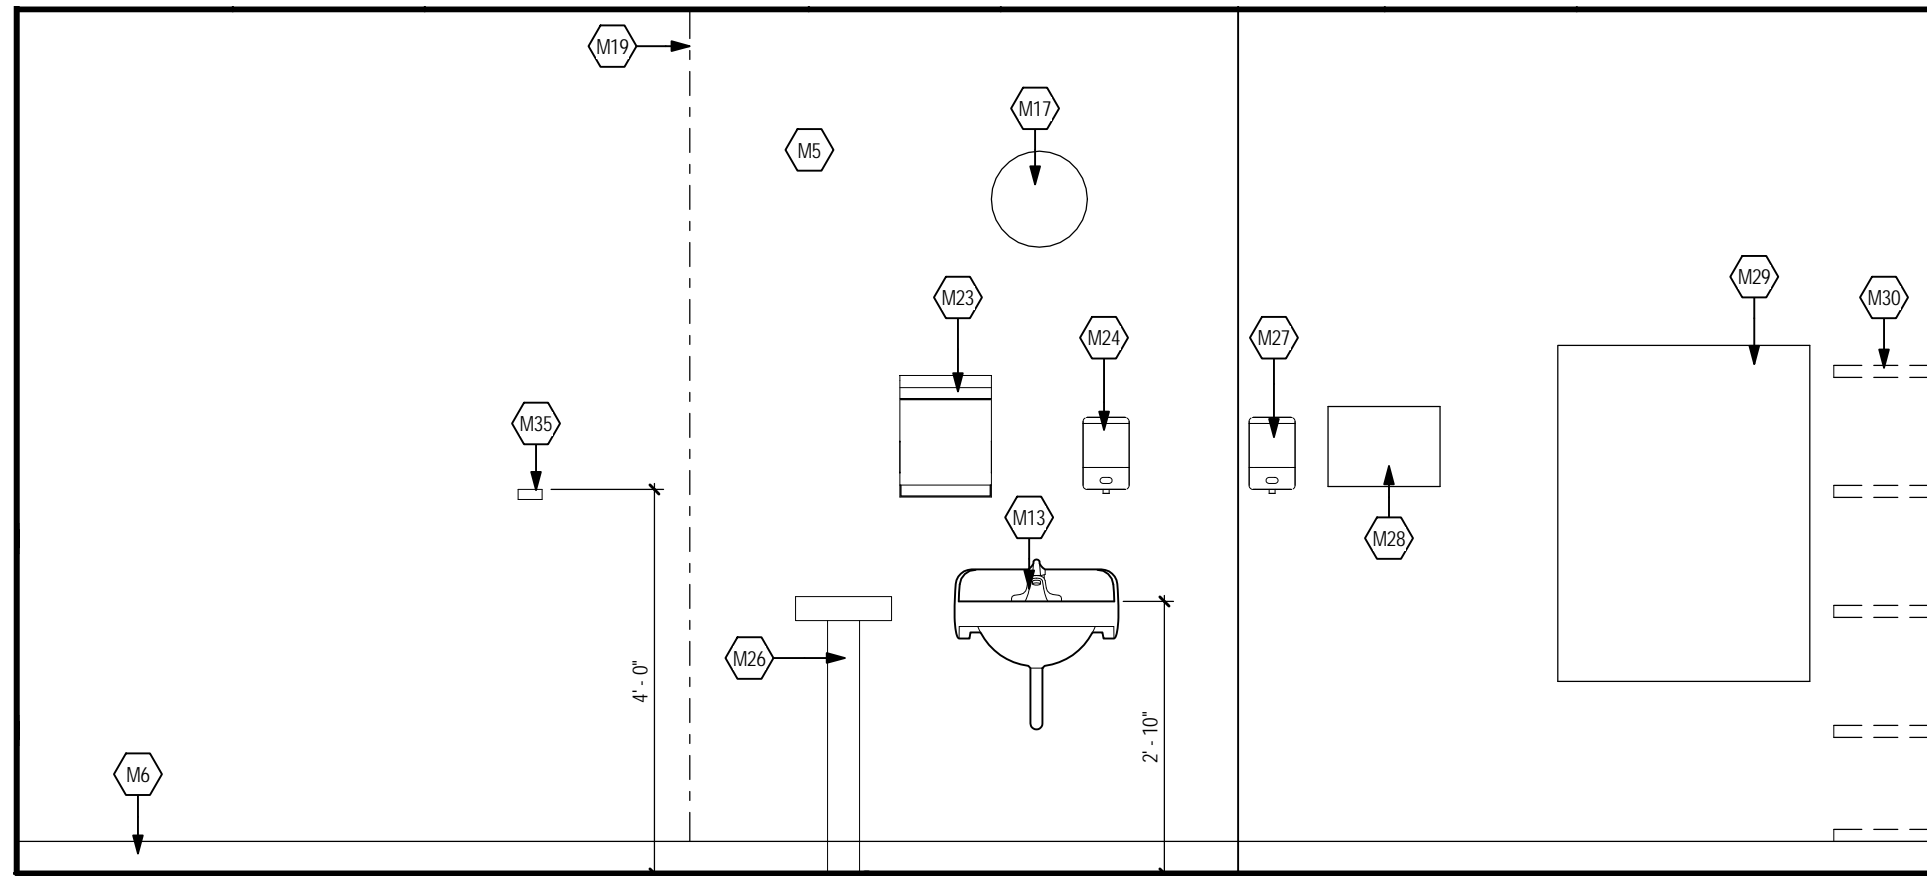

5 elevation - PTS
A8.3.1 1/2" = 1'-0"

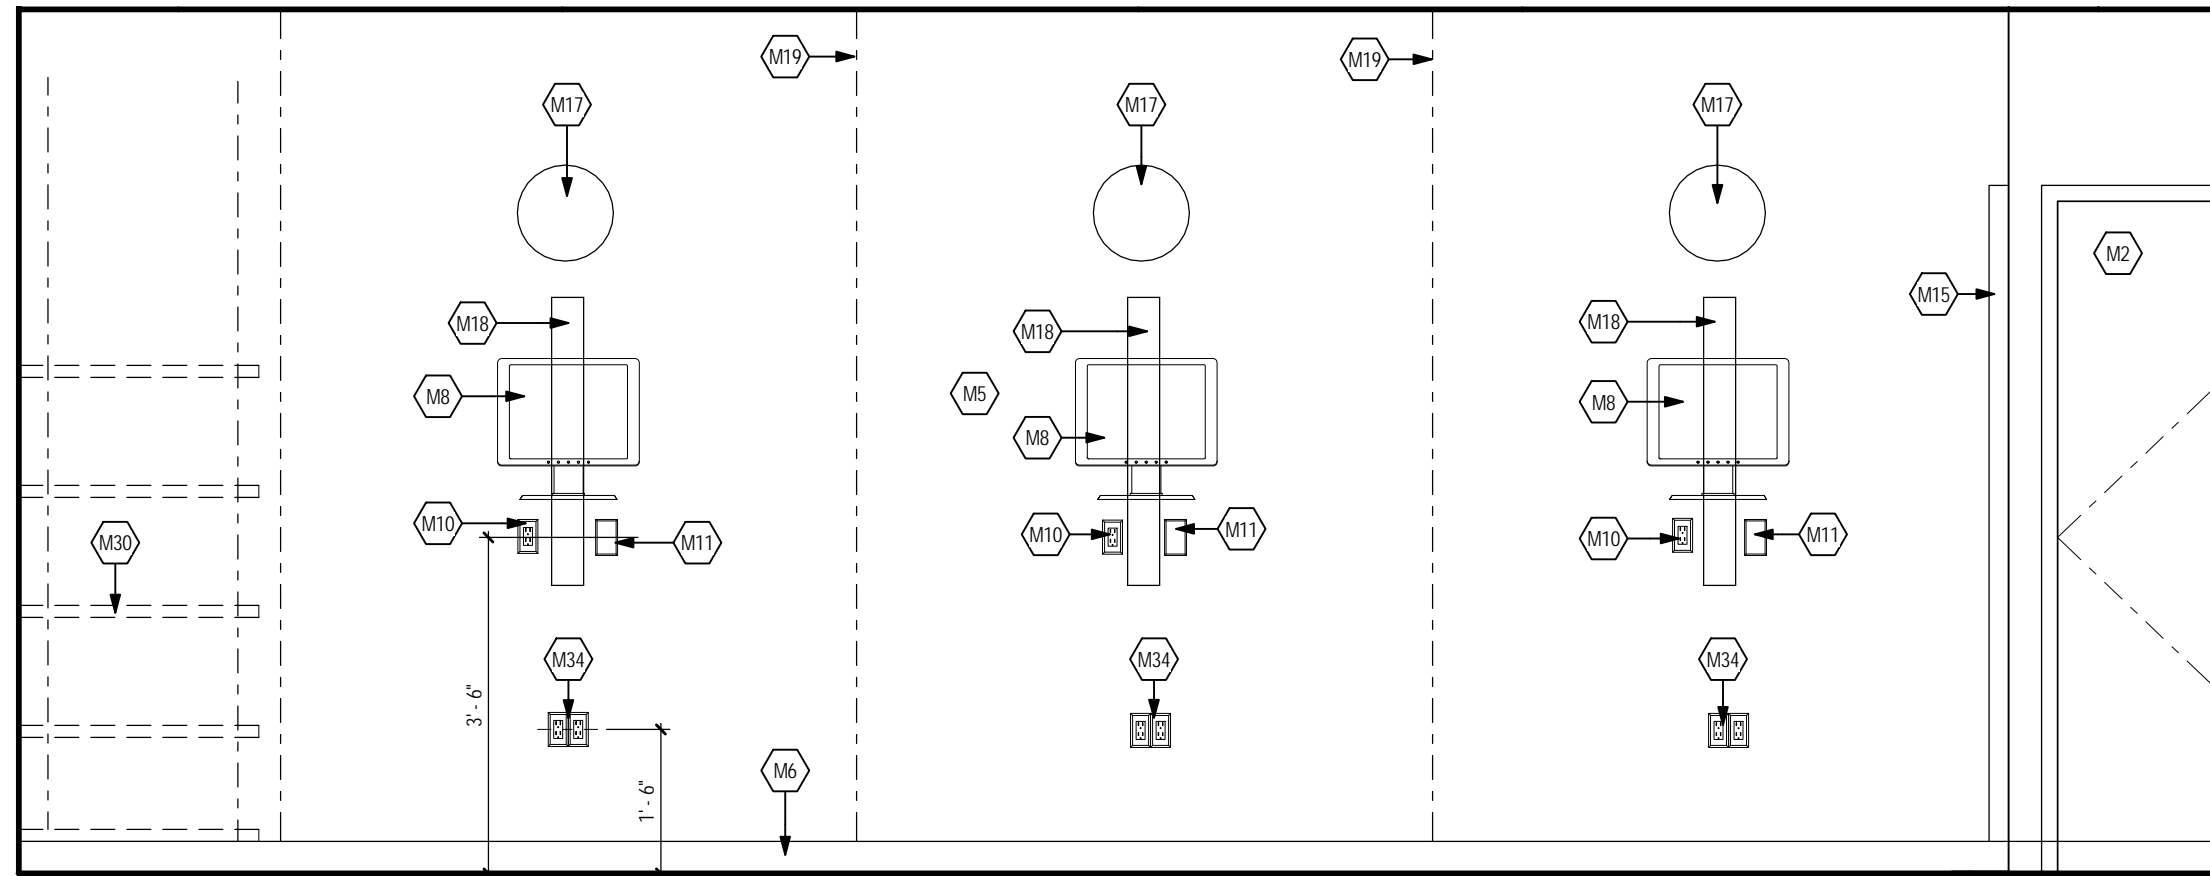

6 elevation - west
A8.3.1 1/2" = 1'-0"

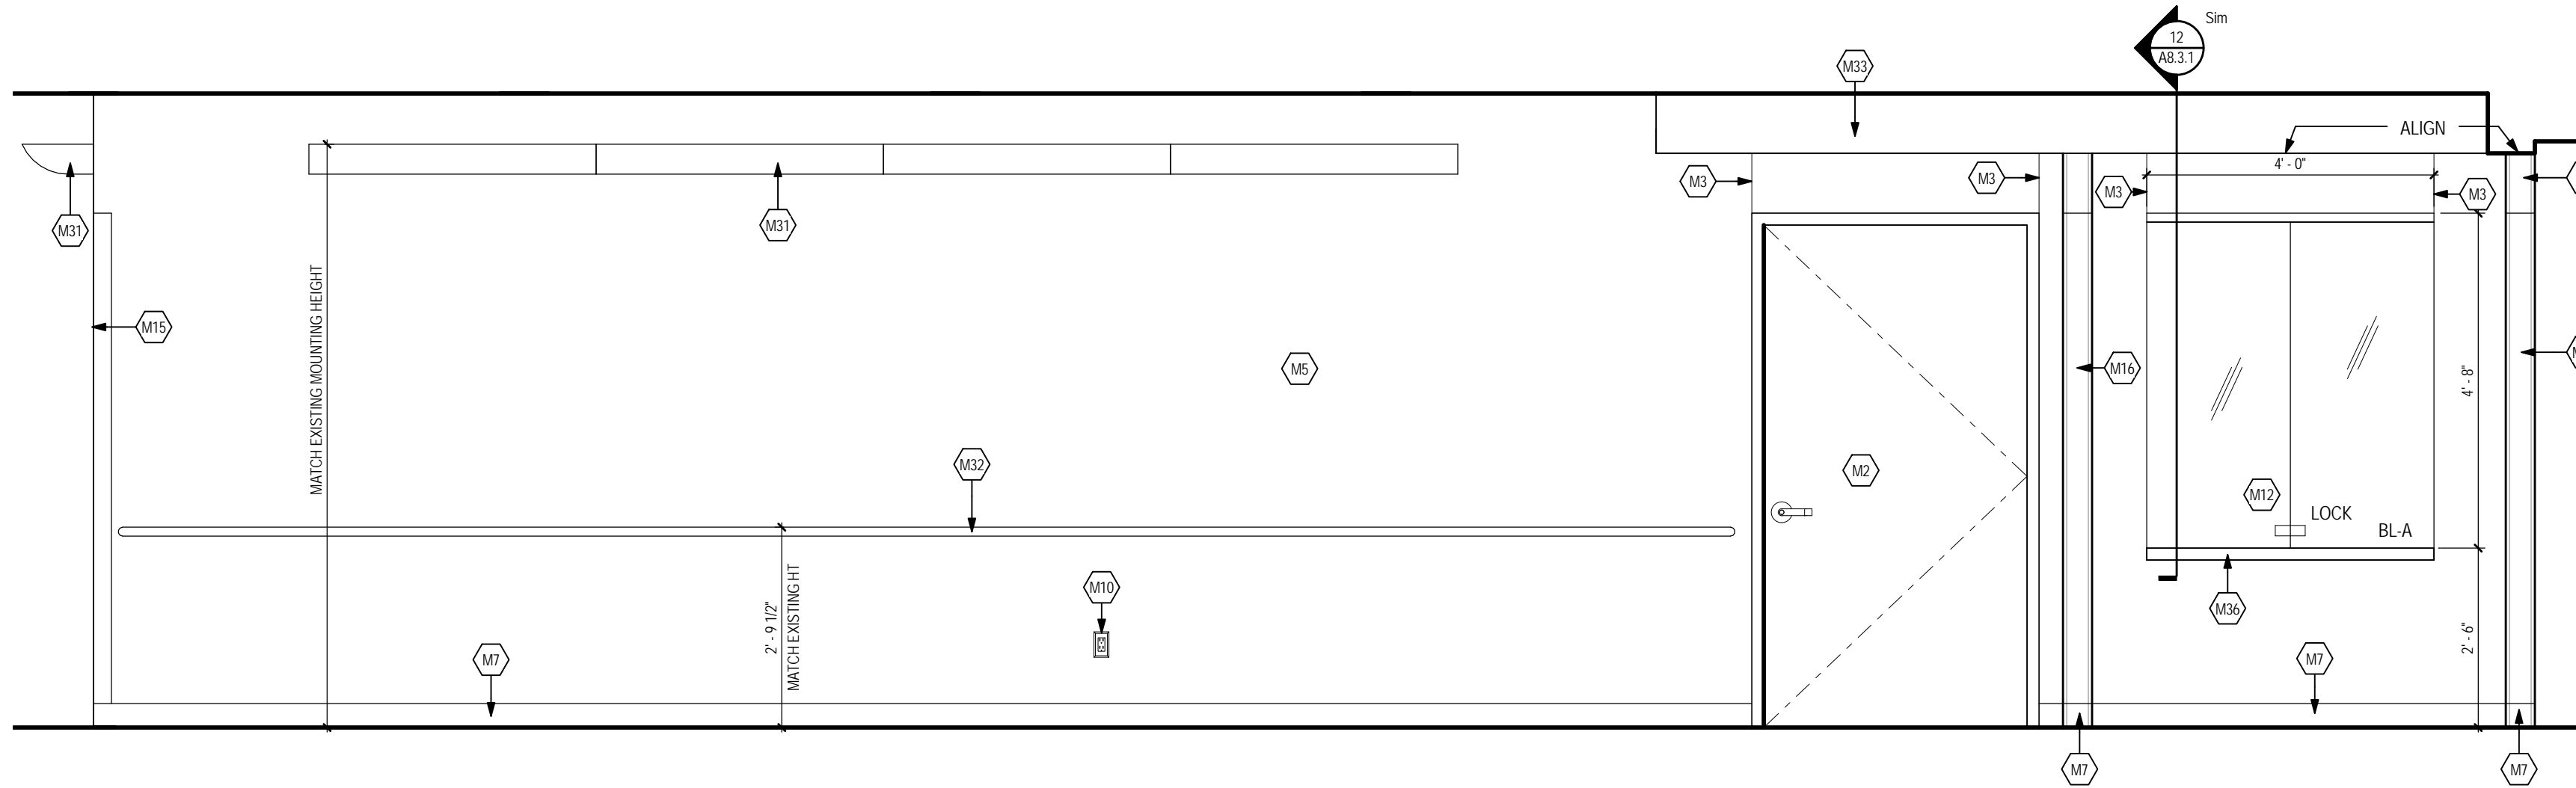

7 elevation - check-in
A8.3.1 1/2" = 1'-0"




8 existing handrail
A8.3.1 1/32" = 1'-0"




9 existing door hardware
A8.3.1 1/32" = 1'-0"




10 existing cove lighting
A8.3.1 1/32" = 1'-0"

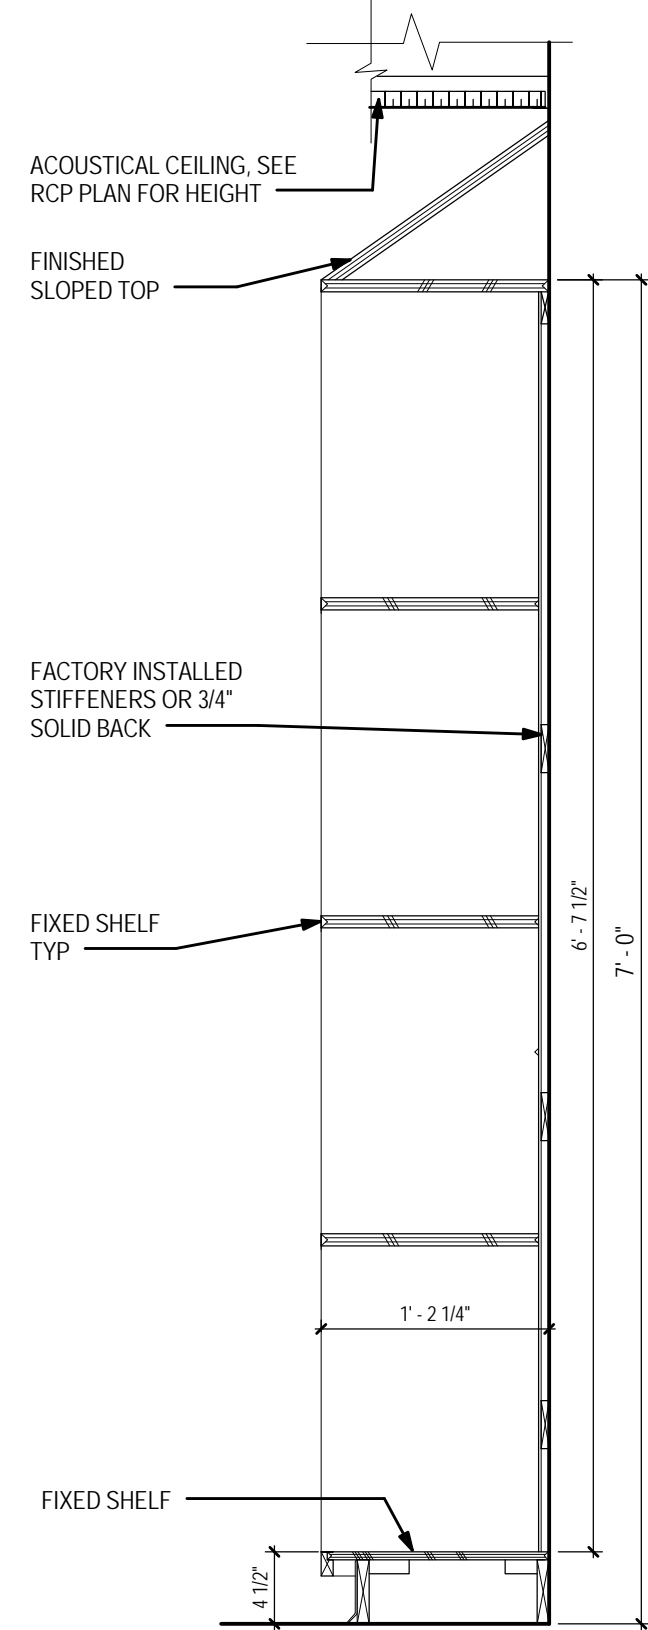


11 section - tall cabinet
A8.3.1 1" = 1'-0"

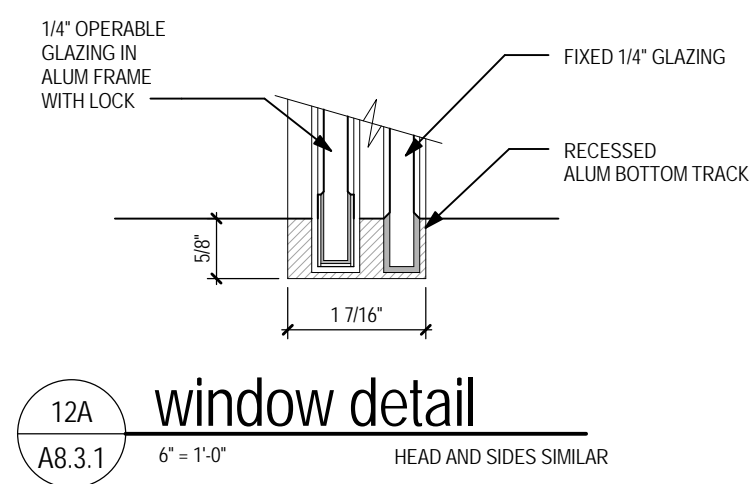

12A window detail
A8.3.1 6" = 1'-0"

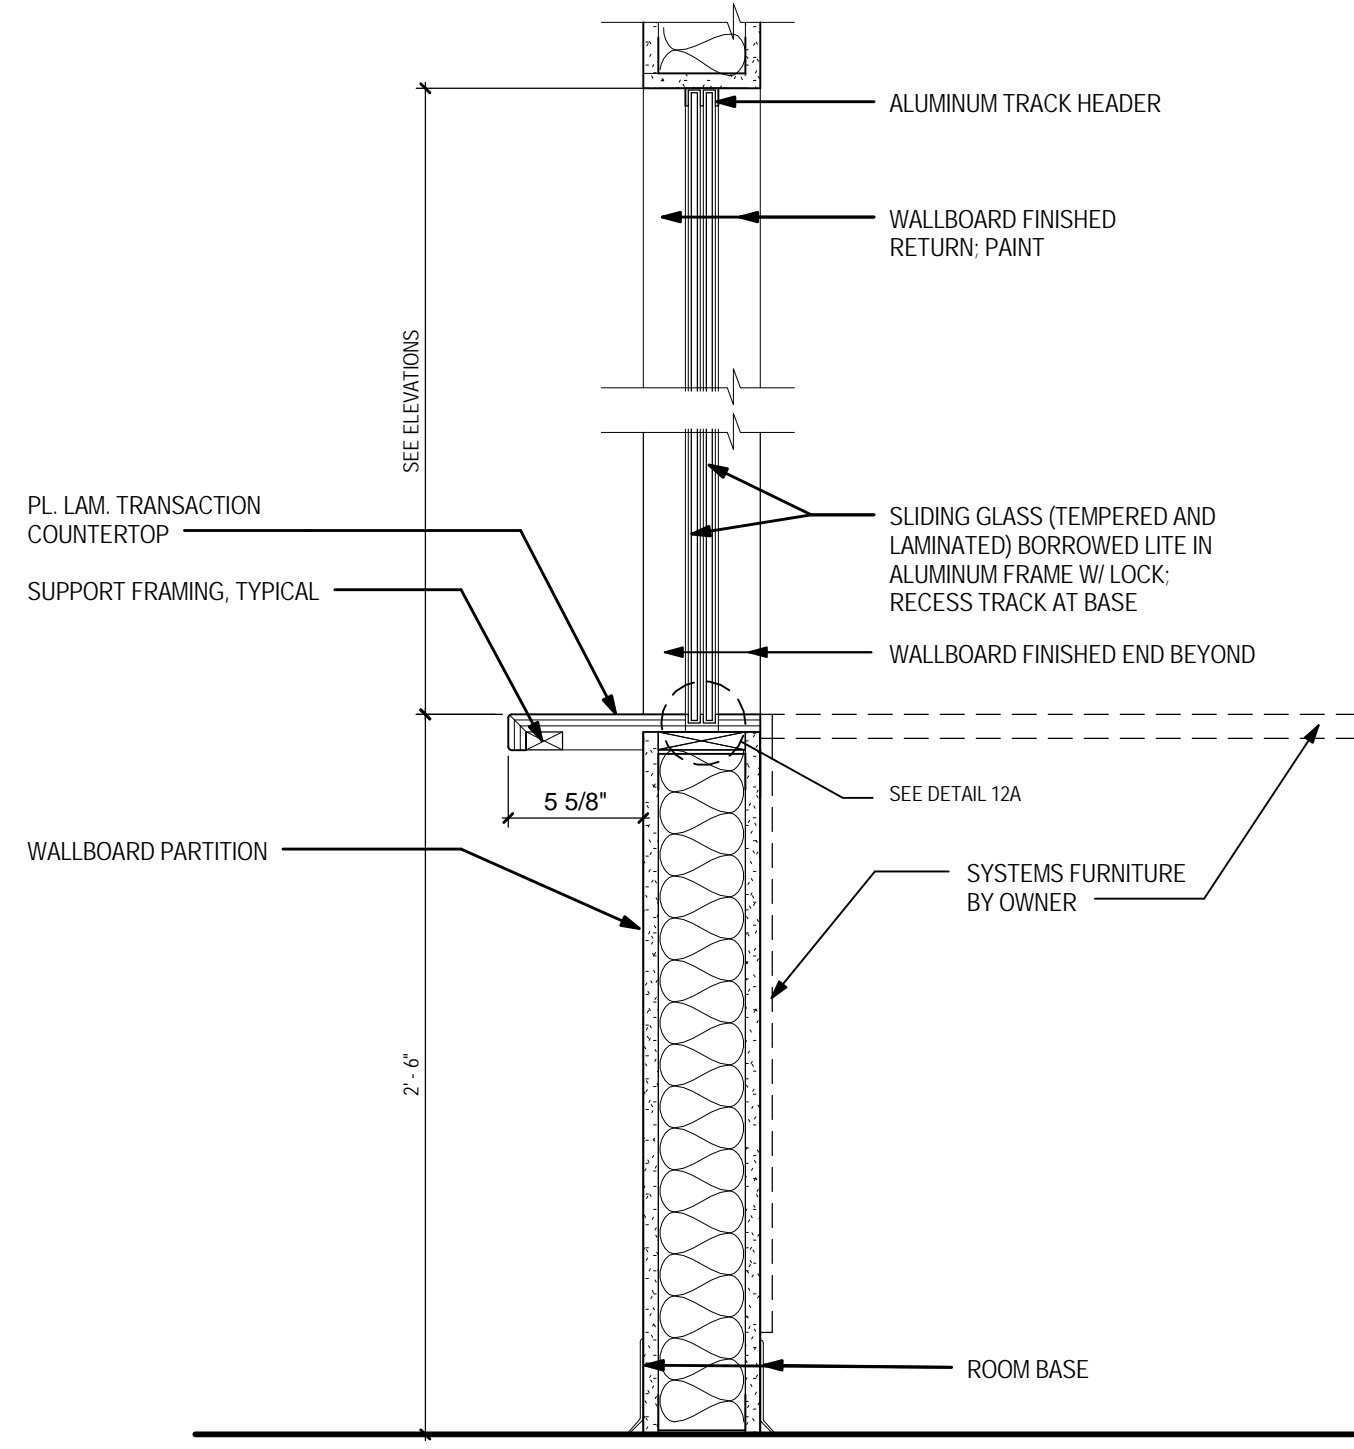

12 section - intake counter BL-A
A8.3.1 1 1/32" = 1'-0"

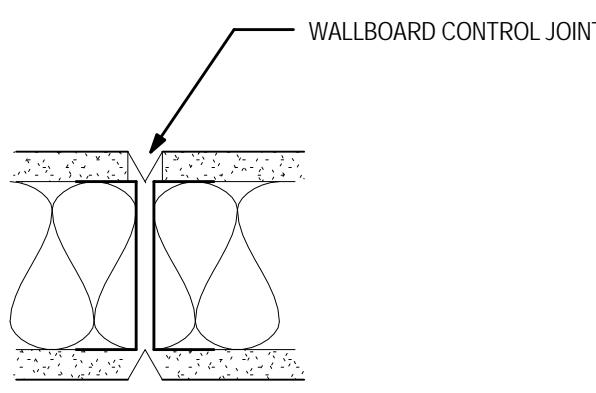

13 non-rated control joint
A8.3.1 3" = 1'-0"



ELEVATION GENERAL NOTES

- REFER TO SPECIFICATIONS FOR MORE INFORMATION REGARDING EXACT CABINET CONSTRUCTION AND HARDWARE REQUIREMENTS.
- APPLY FINISH GRADE PLASTIC LAMINATE TO ALL EXPOSED AND SEMI-EXPOSED SURFACES OF MILLWORK. REFER TO SPECIFICATIONS.
- FIELD VERIFY ALL DIMENSIONS BEFORE FABRICATING MILLWORK AND RELATED COMPONENTS.
- COORDINATE WITH ELECTRICAL AND PLUMBING CONTRACTORS TO LOCATE THEIR WORK AS REQUIRED TO ACCOMMODATE CASEWORK SHOWN HERE.
- PROVIDE 1" RADIUS ON ALL EXPOSED OUTSIDE COUNTER CORNERS.
- PROVIDE NON-COMBUSTIBLE WOOD BLOCKING AT TOP, MIDDLE AND BOTTOM OF ALL TALL WALL CABINETS.
- PAINT ALL WOOD CLEATS TO MATCH ADJACENT WALL.
- PAINT ALL EXPOSED WOOD BLOCKING TO MATCH ADJACENT WALL.
- ALL COUNTERTOPS AND BACKSPLASHES TO BE CAULKED TO WALL FLUSH W/ TOP OF SPLASH OR COUNTER.
- PROVIDE FIRE TREATED BLOCKING IN WALL BEHIND ALL CABINETS.
- SEE MATERIAL FINISHES IN SPECIFICATIONS.
- VERIFY DIMENSIONS OF ALL OF/OE EQUIPMENT SITTING INSIDE / ON MILLWORK CABINETS.

ELEVATION CODED NOTES

- M1 EXISTING FRAMED OPENING TO REMAIN.
M2 NEW DOOR FRAME AND HINGES. REINSTALL BALANCE OF EXISTING HARDWARE FROM SALVAGED DOOR FROM THIS LOCATION. PAINT FRAME.
M3 CONTROL JOINT IN PARTITION TO ALIGN WITH EDGE OF DOOR FRAME OR WINDOW EDGE. BOTH SIDES OF WALL PARTITION. SEE DETAIL THIS SHEET.
M4 SYSTEMS FURNITURE. OF/OE. CONTRACTOR TO PROVIDE BLOCKING IN WALL FOR OWNER. REPAIR WALLBOARD TO MATCH SAME LEVEL OF FINISH.
M5 PAINT WALL. SEE FINISH SCHEDULE.
M6 INTEGRAL ROOM BASE WITH ALUMINUM CAP. SEE FINISH SCHEDULE.
M7 RESILIENT ROOM BASE. SEE FINISH SCHEDULE.
M8 EQUIPMENT. OF/OE.
M9 LIGHT SWITCH. SEE ELECTRICAL DRAWINGS.
M10 ELECTRICAL DUPLEX OUTLET. SEE ELECTRICAL DRAWINGS.
M11 DATA OUTLET. SEE ELECTRICAL DRAWINGS.
M12 SLIDING GLASS WINDOW WITH LOCK.
M13 SINK. PROVIDE INSULATION WRAP ON DRAIN. SEE PLUMBING DRAWINGS.
M14 MILLWORK. SEE DETAILS.
M15 NEW STAINLESS STEEL CORNER GUARD.
M16 NEW STAINLESS STEEL END CAP.
M17 CLOCK. OF/OE (OWNER FURNISHED, CONTRACTOR INSTALLED).
M18 WALL MOUNTED COMPUTER BRACKET ARM. OF/OE.
M19 CUBICLE CURTAIN TRACK AT CEILING. CURTAIN OF/OE.
M20 PLASTIC LAMINATE SLOPED TOP. SEE DETAILS.
M21 PLASTIC LAMINATE FINISHED END PANEL.
M22 COAT ROD.
M23 PAPER TOWEL DISPENSER. OF/OE.
M24 SOAP DISPENSER. OF/OE.
M25 SAFETY CONE WALL DISPENSER. OF/OE.
M26 EYE WASH. SEE PLUMBING DRAWINGS.
M27 ALCOHOL HAND DISPENSER. OF/OE.
M28 GLOVES DISPENSER. OF/OE.
M29 EXISTING PNEUMATIC TUBE STATION TO REMAIN.
M30 PLASTIC LAMINATE SHELVES. OF/OE. CONTRACTOR TO PROVIDE BLOCKING IN EXISTING WALL AND REPAIR WALLBOARD IN PREPARATION OF OWNERS SHELVES.
M31 REINSTALL EXISTING SALVAGED WALL MOUNTED LIGHT FIXTURES. SEE ELECTRICAL DRAWINGS.
M32 WOOD HANDRAIL. CONTRACTOR TO PROVIDE BLOCKING IN NEW AND EXISTING WALLS. CONTRACTOR TO REPAIR EXISTING PARTITION WALLBOARD TO SAME LEVEL OF FINISH AS EXISTING.
M33 WALLBOARD SOFFIT. PAINT ACCENT COLOR. SEE FINISH SCHEDULE.
M34 ELECTRICAL QUAD OUTLET. SEE ELECTRICAL DRAWINGS.
M35 COAT HOOK. OF/OE.
M36 PLASTIC LAMINATE TRANSACTION COUNTERTOP. SEE DETAIL.

CONSTRUCTION DOCUMENTS – BID SET

Drawing Title INTERIOR ELEVATIONS AND DETAILS		Project Title Expand Specimen Collection Area		Project Number 757-17-207		Office of Construction and Facilities Management
Approved:		Location CHALMERS P. WYLIE VA AMBULATORY CARE CENTER		Building Number 1A		
Date 10 JULY 2015		Checked By: ds		Drawing Number A8.3.1		 Columbus VA <small>Central VA Health Care System</small>  Department of Veterans Affairs
		Drawn By: mrh				


CONTRACT DOCUMENTS – BID SET	7/10/15
CONTRACT DOCUMENTS – 100%	6/10/15
CONTRACT DOCUMENTS – 90% REVIEW SET	5/15/15
DESIGN DEVELOPMENT – 60% REVIEW SET	4/10/15
Revisions:	Date

CONSULTANTS:	
DynamiX Engineering Ltd. Facility Engineering Consultants 855 Grandview Avenue, 3rd Floor Columbus, OH 43215 Phone: (614) 443-1178 Fax: (614) 443-1594 Email: dynamix@dynamix-tld.com DEL # 13066	




ARCHITECT/ENGINEERS:	
ma 775 Yard Street, Suite 325 Columbus, Ohio 43212 p 614.764.0407 f 614.764.0237 www.ma-architects.com	

one eighth inch = one foot
one quarter inch = one foot
one half inch = one foot
three eighths inch = one foot
one inch = one foot
one and one half inches = one foot
three inches = one foot

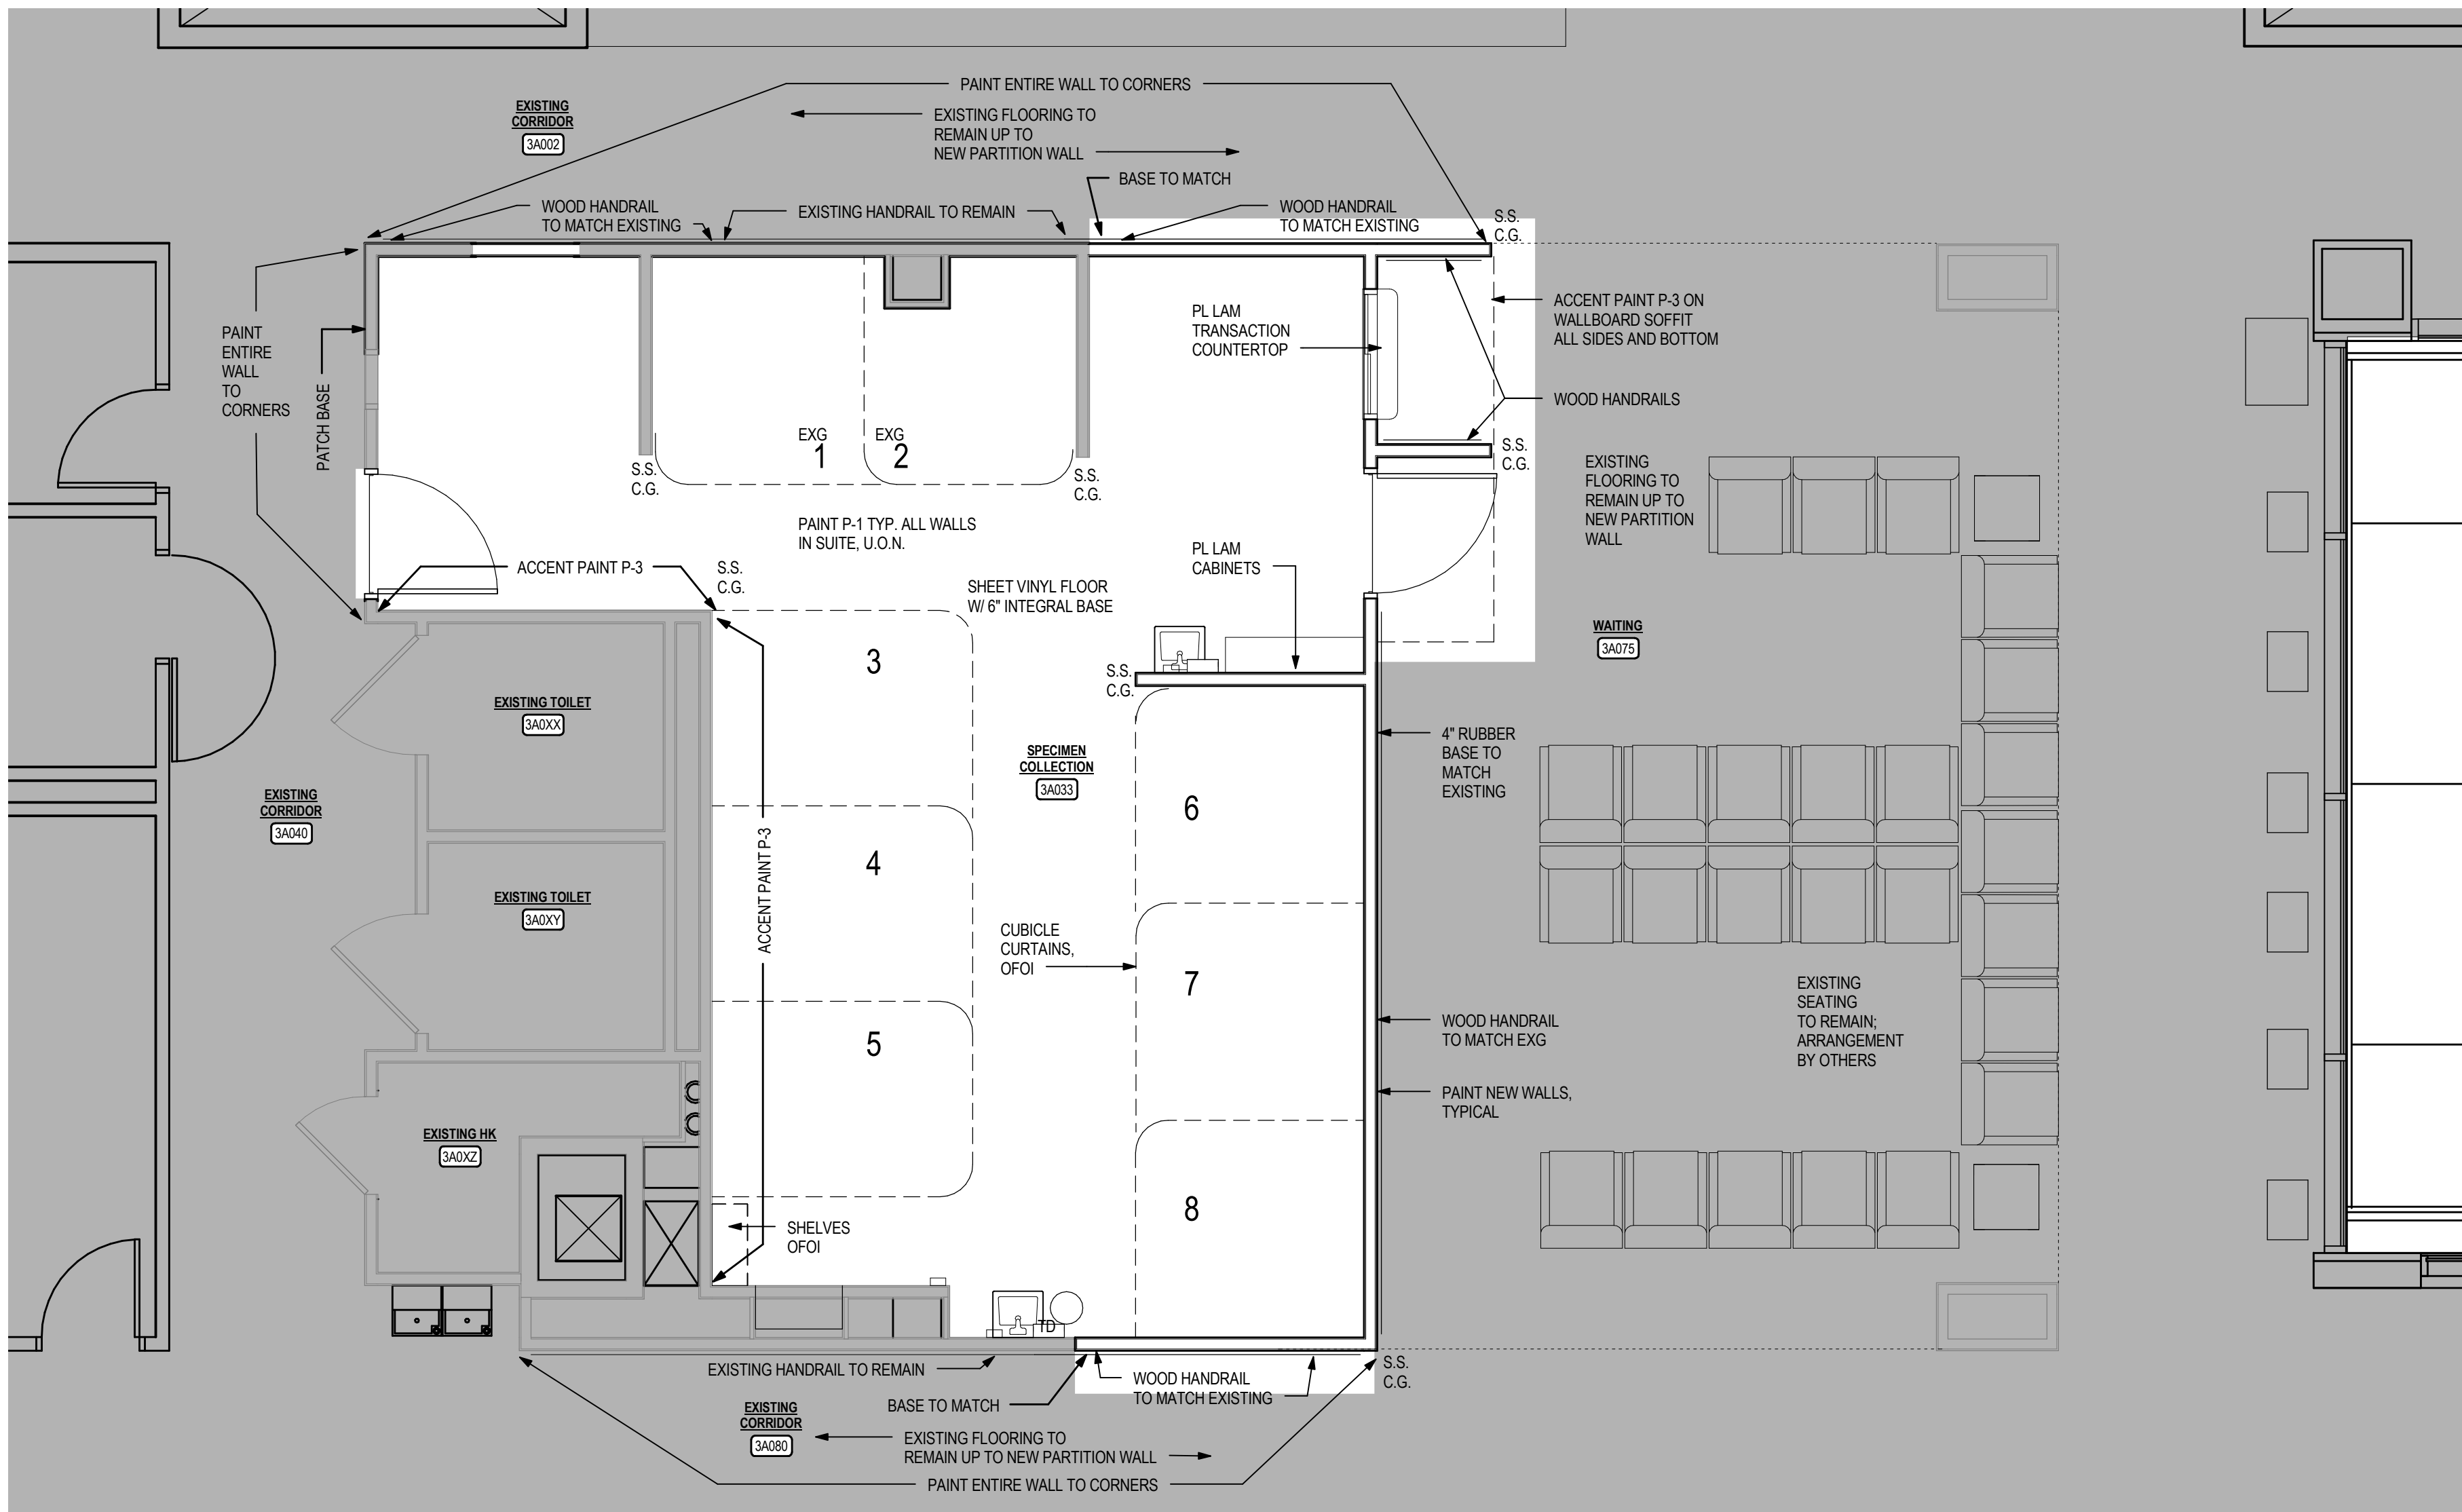

1 partial third floor - finish plan
1/8" = 1'-0"

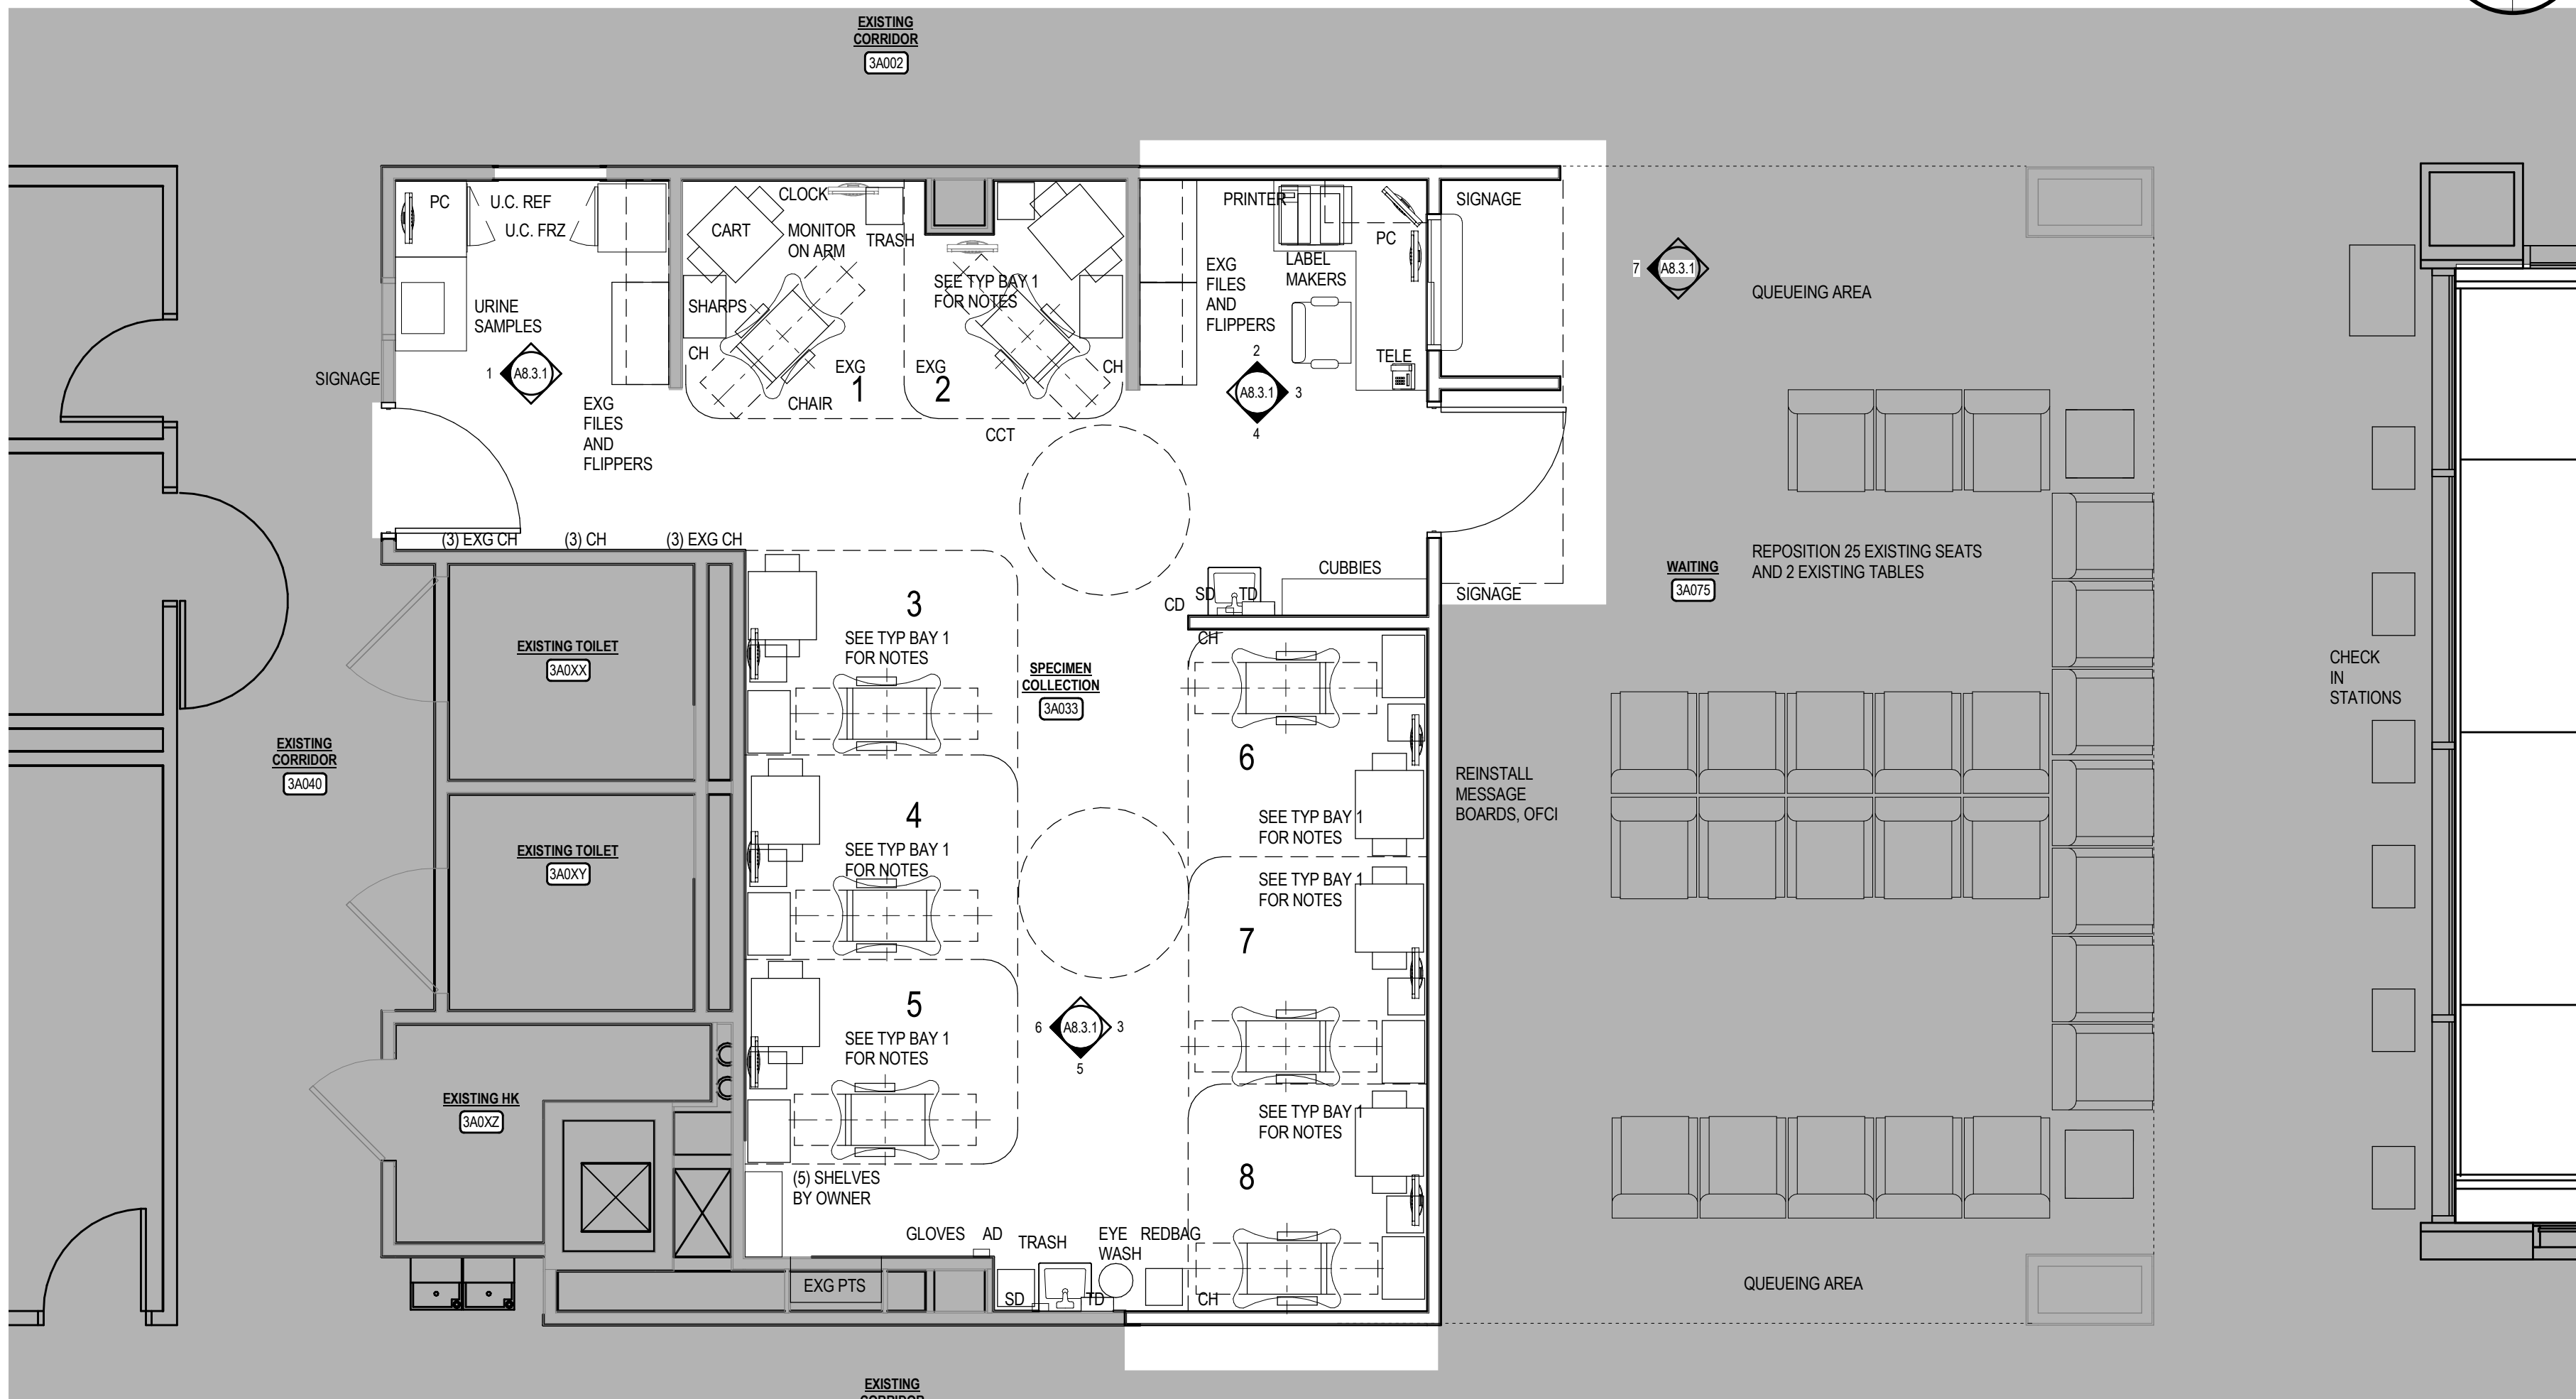

2 partial third floor - equipment plan
1/8" = 1'-0"

ROOM FINISH SCHEDULE										
ROOM NO	ROOM NAME	FLOOR	BASE	WALLS (SUBSTRATE/FINISH)				CEILING MAT'L/FINISH	REMARKS	
				NORTH	EAST	SOUTH	WEST			
3A002	EXISTING CORRIDOR	EXG	MATCH EXG	EXG	-	P-1	-	EXG	MATCH EXISTING FINISHES	
3A003	SPECIMEN COLLECTION	WSF-1	WSF-1	P-1	P-1	P-1P-3	P-1P-3	ACT-1	SEE PLANS FOR ACCENT WALL PAINT LOCATIONS	
3A004	EXISTING CORRIDOR	EXG	MATCH EXG	-	P-1	-	EXG	EXG	MATCH EXISTING FINISHES	
3A005	WAITING	EXG	MATCH EXG	EXG	-	EXG	-	P-1	SEE PLANS FOR ACCENT PAINT ON SOFFIT	
3A006	EXISTING CORRIDOR	EXG	MATCH EXG	P-1	-	EXG	-	EXG	MATCH EXISTING FINISHES	

SEE PROJECT MANUAL, SECTION 09 06 00 SCHEDULE FOR FINISHES


FINISH PLAN GENERAL NOTES

- A. SEE SHEET 09-02 FOR WALL TYPES.
B. SEE SHEET A2.3.1 FOR FLOOR PLANS.
C. SEE SHEET A2.3.1 FOR CEILING HEIGHTS AND PAINTED SOFFIT COLORS.
D. PATCH AND REPAIR ANY SURFACE OR OTHER ITEM DAMAGE BY OR INVOLVED IN CONSTRUCTION ACTIVITIES TO "AS NEW". REFER TO ENGINEERING DRAWINGS FOR MEP WORK THAT MAY REQUIRE PATCHING BY GENERAL TRADES CONTRACTOR.
E. NEW AND EXISTING DOOR FRAMES TO BE PAINTED P-2, EXCEPT WHERE NOTED OTHERWISE.
F. WHERE POSSIBLE, PAINT COLOR AS NOTED SHOULD EXTEND TO LOGICAL TERMINATION POINT - INSIDE CORNER, REVEAL, OR ADJACENT MATERIAL.
G. ALL FLOORS, WALLS, CEILINGS, TRIM AND MISCELLANEOUS FEATURES THROUGHOUT THIS PACKAGE, SHALL RECEIVE NEW FINISHES, COLOR, TYPE, AND PATTERN AS NOTED ON A9.3.1 FINISH DRAWINGS AND IN PROJECT MANUAL.



EQUIPMENT PLAN GENERAL NOTES

- A. PLAN FOR REFERENCE ONLY. PLANS TO BE FINALIZED AFTER FFE FINAL SELECTIONS ARE MADE.
B. EQUIPMENT SHOWN FOR DESIGN INTENT REFERENCE ONLY.
C. ALL NOTED FURNITURE OWNER FURNISHED, OWNER INSTALLED (OFOI).
D. SIGNAGE IS OWNER PROVIDED AND OWNER INSTALLED.
E. EXISTING EQUIPMENT WILL BE MOVED BY THE OWNER DURING CONSTRUCTION. COORDINATE SCHEDULE WITH THE OWNER FOR EQUIPMENT MOVES.

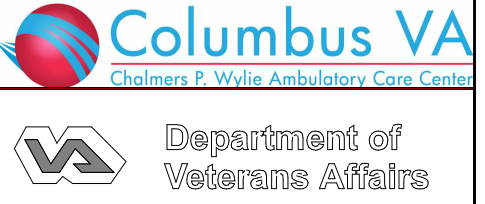CONSTRUCTION DOCUMENTS – BID SET

Drawing Title PARTIAL THIRD FLOOR – FINISH AND EQUIPMENT PLANS		Project Title Expand Specimen Collection Area		Project Number 757-17-207	Office of Construction and Facilities Management  Department of Veterans Affairs
Approved:		Location CHALMERS P. WYLIE VA AMBULATORY CARE CENTER		Building Number 1A	
Date 10 JULY 2015		Checked By: ds	Drawn By: mrrh	Drawing Number A9.3.1	

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